


PROJECT: 45340.3.FR8 TIP:W-5210H

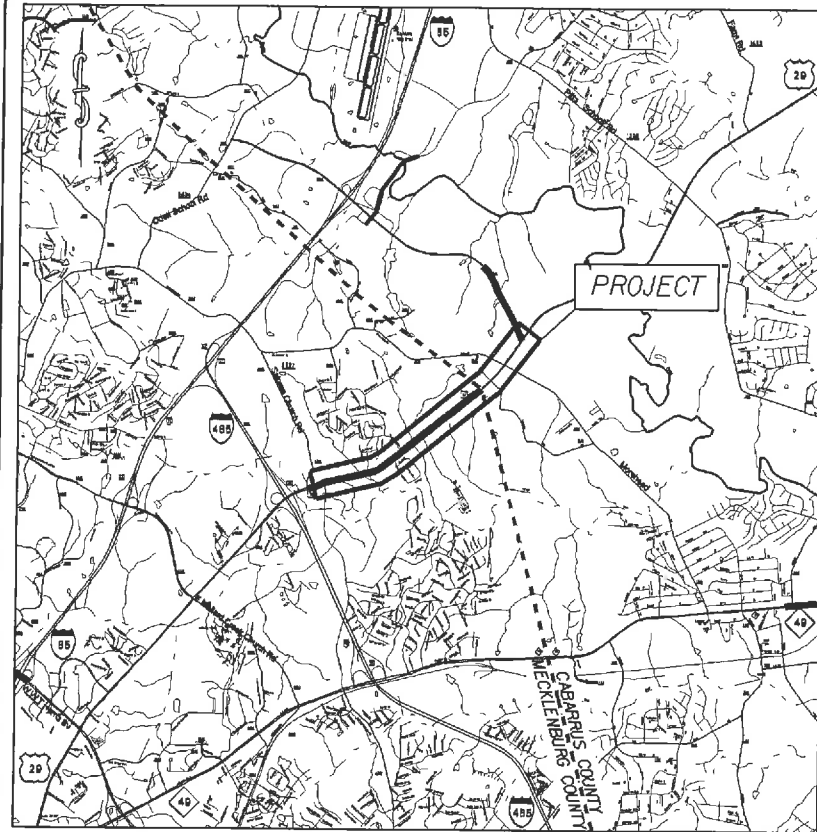

VICINITY MAP NOT TO SCALE


STATE OF NORTH CAROLINA
DIVISION OF HIGHWAYS

MECKLENBURG COUNTY & CABARRUS COUNTY


LOCATION: US 29 FROM PAVILION BLVD. TO BRUTON SMITH BLVD.

TYPE OF WORK: GRADING, PAVING, DRAINAGE, CONCRETE ISLANDS & THERMOPLASTIC PAVEMENT MARKINGS

STATE	STATE PROJECT REFERENCE NO.	SHEET NO.	TOTAL SHEETS
N.C.	45340.3.FR8	1	
STATE PROJ. NO.	F.A. PROJ. NO.	DESCRIPTION	
45340.1.FR8	HSIP-0029(60)	P.E.	
45340.2.FR8		R/W	
45340.3.FR8		CONST.	

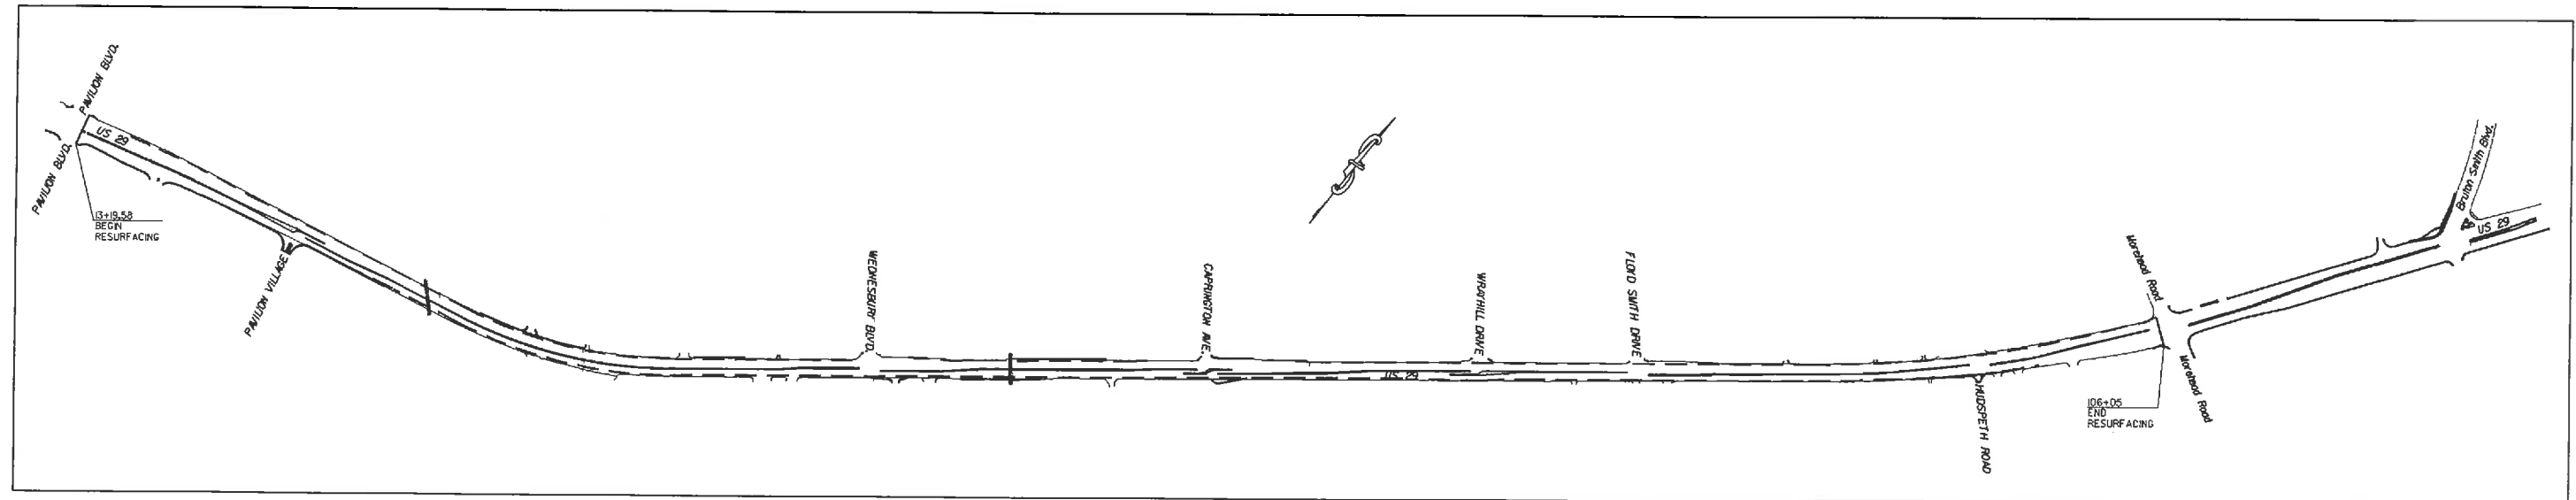

GRAPHIC SCALES

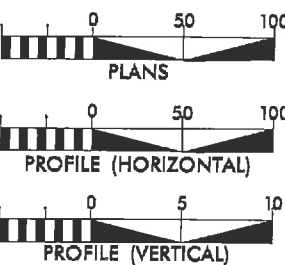

DESIGN DATA

ADT	=	
ADT	=	
DHV	=	%
D	=	%
T	=	%
V	=	MPH

PROJECT LENGTH

LENGTH OF ROADWAY PROJECT 45340.3.FR8	=	1.98	MILES
TOTAL LENGTH OF STATE PROJECT 45340.3.FR8	=	1.98	MILES

Prepared in the Office of:
DIVISION OF HIGHWAYS
DIVISION TEN
DIVISION DESIGN / CONSTRUCT UNIT

2012 STANDARD SPECIFICATIONS

RIGHT OF WAY DATE:

LETTING DATE:
August 27, 2014

RANDY BOWERS
PROJECT ENGINEER


TERRY BURLESON
PROJECT DESIGN ENGINEER




DIVISION OF HIGHWAYS
STATE OF NORTH CAROLINA

APPROVED BY _____ DATE _____
D/C ENGINEER


STATE	PROJECT NO.	SHEET NO.	TOTAL SHEETS
N.C.	45340.3.FR8	2	
F.A. PROJECT NO.			

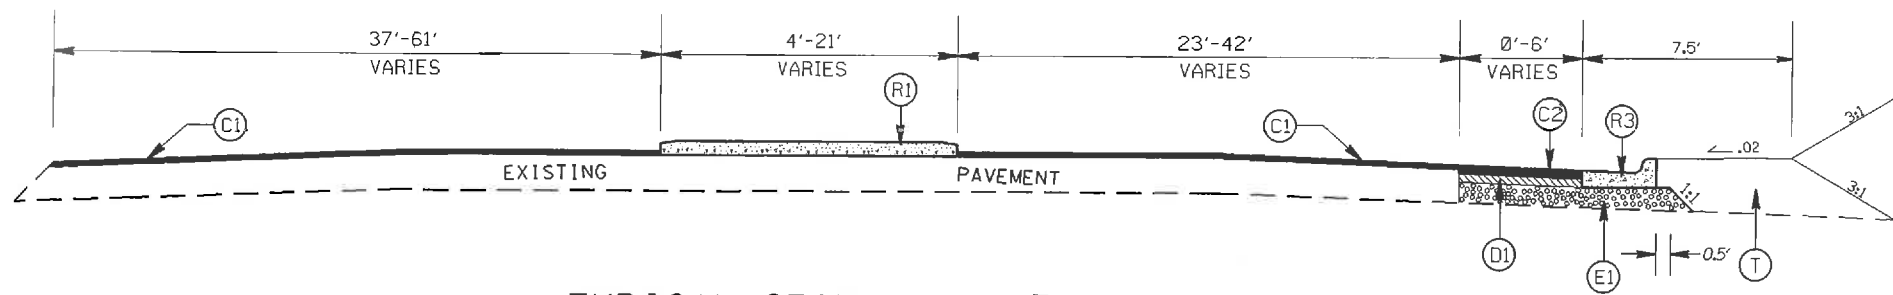

TYPICAL SECTION NO.3
STA 19+12 TO 24+06.61 -L-

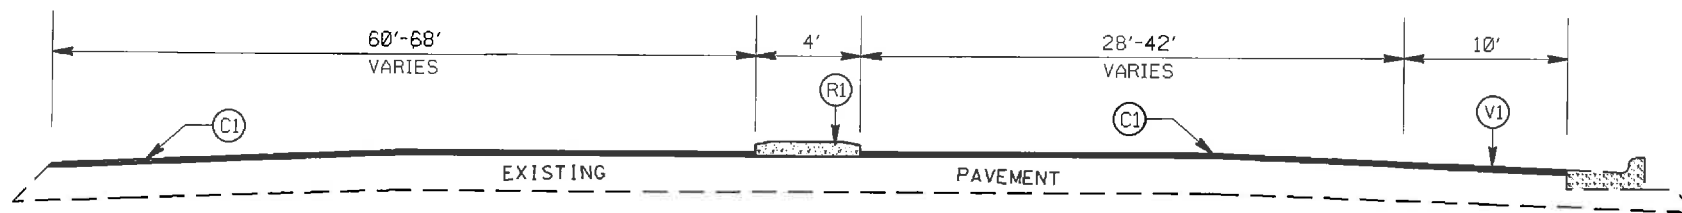

TYPICAL SECTION NO.2
STA 17+85 TO 19+12 -L-

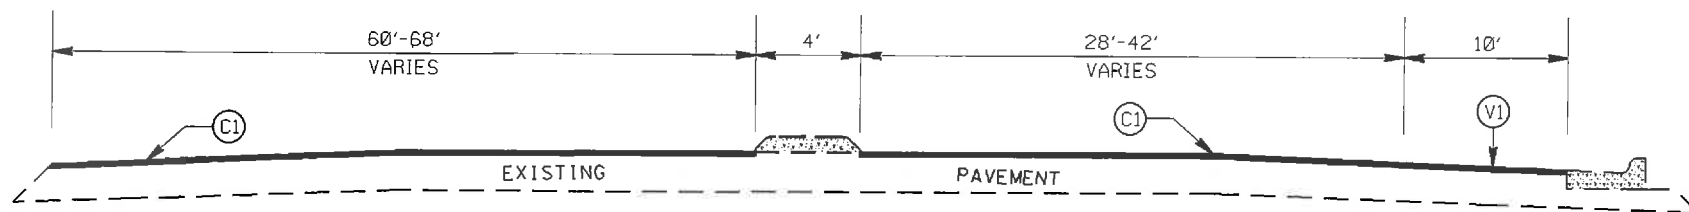

TYPICAL SECTION NO.1
STA 13+19 TO 17+85 -L-

PAVEMENT SCHEDULE

(C1)	PROP. APPROX. 1½" ASPHALT CONC. SURFACE COURSE, TYPE S9.5C, AT AN AVERAGE RATE OF 168 LBS. PER SQ. YD.
(C2)	PROP. APPROX. 3" ASPHALT CONC. SURFACE COURSE, TYPE S9.5C, AT AN AVERAGE RATE OF 168 LBS. PER SQ. YD. IN EACH OF TWO LAYERS.
(D1)	PROP. APPROX. 4" ASPHALT CONC. BINDER COURSE, TYPE I19.0C, AT AN AVERAGE RATE OF 456 LBS. PER SQ. YD.
(E1)	PROP. APPROX. 5.5" ASPHALT CONC. BASE COURSE, TYPE B25.0C, AT AN AVERAGE RATE OF 627 LBS. PER SQ. YD.
(R1)	PROP. 5" MONOLITHIC CONCRETE ISLAND (KEYED IN)
(R2)	PROP. 5" MONOLITHIC CONCRETE ISLAND (SURFACE MOUNTED)
(R3)	PROP. 2'-6" CURB & GUTTER
(R4)	PROP. 1'-6" CURB & GUTTER
(R5)	PROP. 4" CONCRETE SIDEWALK
(T)	EARTH MATERIAL
(V1)	MILLING ASPHALT PAVEMENT, 0' TO 1.5' IN DEPTH


US 29 FROM PAVILLION BLVD. TO
BRUTON SMITH BLVD.

SCALE	1"=50'
DATE	5/14
DWG. BY	JDH
DESIGN BY	JDH
APPROVED	RWB




REVISIONS	

STATE	PROJECT NO.	SHEET NO.	TOTAL SHEETS
N.C.	45340.3.FR8	2A	
F.A. PROJECT NO.			

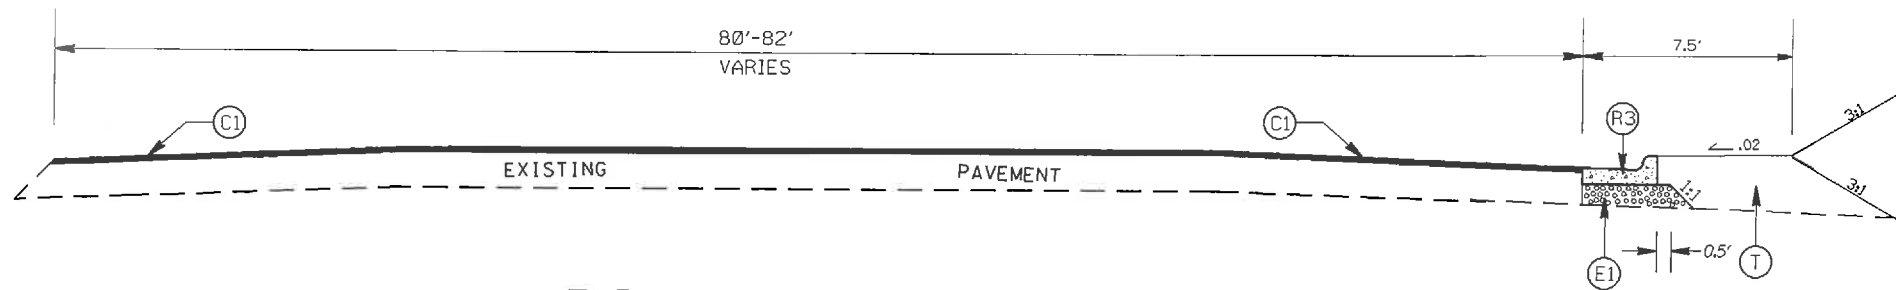


TYPICAL SECTION NO.6

STA 26+86.08 TO 28+08.61 -L-

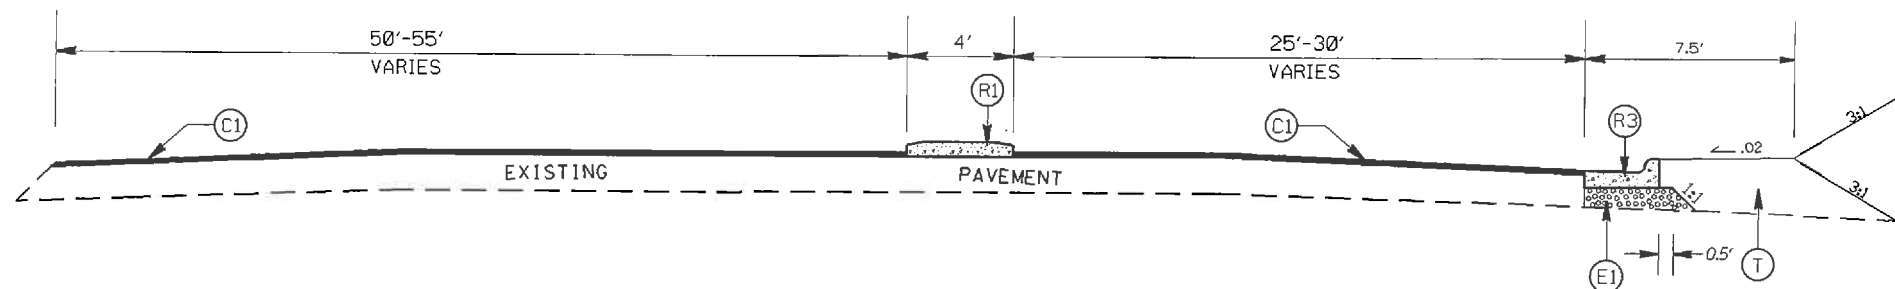

TYPICAL SECTION NO.5

STA 24+92.05 TO 26+86.08 -L-

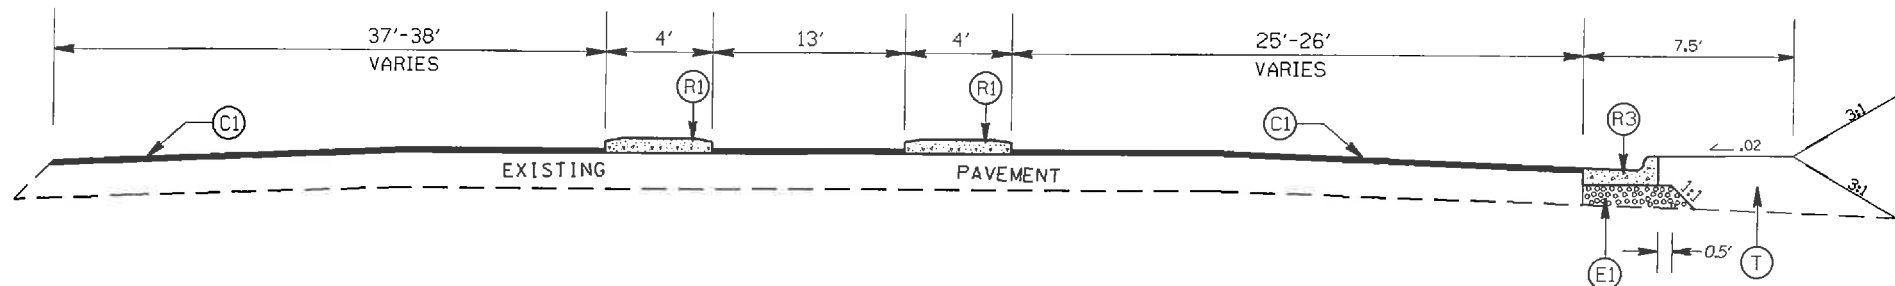

TYPICAL SECTION NO.4

STA 24+06.61 TO 24+92.05 -L-


PAVEMENT SCHEDULE

(C1)	PROP. APPROX. 1½" ASPHALT CONC. SURFACE COURSE, TYPE S9.5C, AT AN AVERAGE RATE OF 168 LBS. PER SQ. YD.
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(R5)	PROP. 4" CONCRETE SIDEWALK
(T)	EARTH MATERIAL
(V1)	MILLING ASPHALT PAVEMENT, 0' TO 1.5' IN DEPTH

US 29 FROM PAVILLION BLVD. TO
BRUTON SMITH BLVD.


SCALE	1"=50'		REVISIONS
DATE	5/14		
DWG. BY	JDH		
DESIGN BY	JDH		
APPROVED	RWB		

STATE	PROJECT NO.	SHEET NO.	TOTAL SHEETS
N.C.	45340.3.FR8	2B	
F.A. PROJECT NO.			

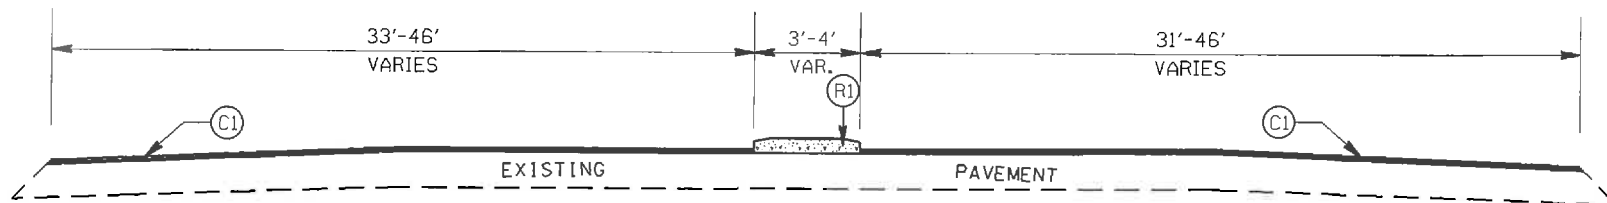


TYPICAL SECTION NO.9

STA 60+94 TO 62+43.89 -L-
 STA 66+54.79 TO 68+04.82 -L-
 STA 69+45.39 TO 71+63.57 -L-

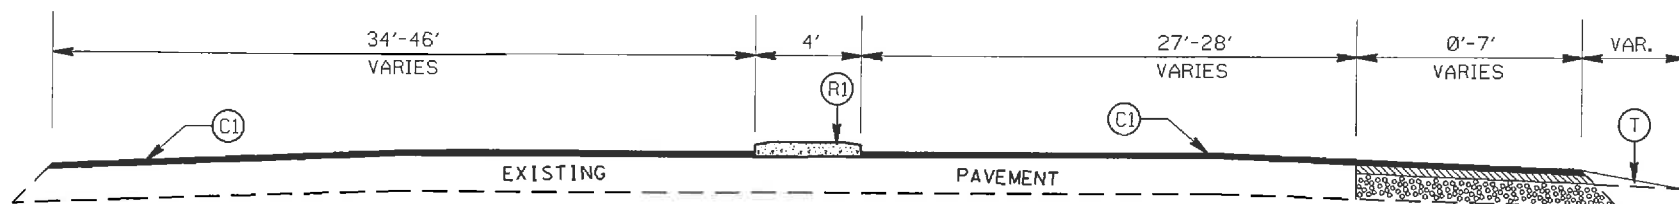

TYPICAL SECTION NO.8

STA 95+08.49 TO 99+41.98 -L-

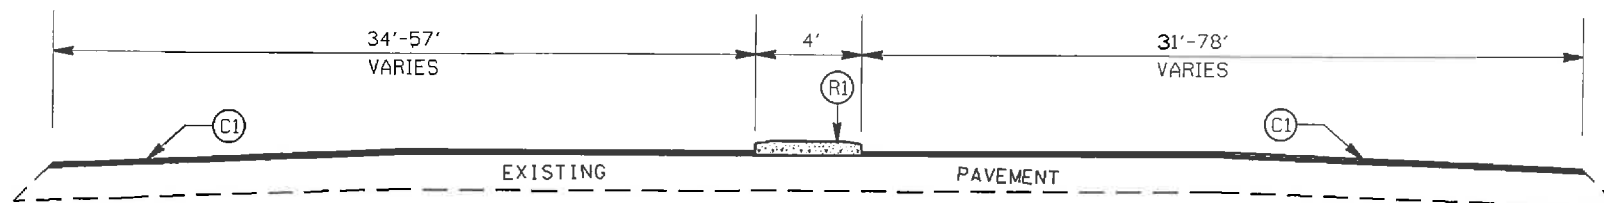

TYPICAL SECTION NO.7

STA 28+08.61 TO 60+94 -L-
 STA 68+04.82 TO 69+45.39 -L-
 STA 78+42.64 TO 95+08.49 -L-
 STA 99+41.98 TO 105+65.44 -L-

PAVEMENT SCHEDULE

(C1)	PROP. APPROX. 1½" ASPHALT CONC. SURFACE COURSE, TYPE S9.5C, AT AN AVERAGE RATE OF 168 LBS. PER SQ. YD.
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(R5)	PROP. 4" CONCRETE SIDEWALK
(T)	EARTH MATERIAL
(V1)	MILLING ASPHALT PAVEMENT, 0' TO 1.5' IN DEPTH


US 29 FROM PAVILLION BLVD. TO
 BRUTON SMITH BLVD.

SCALE	1"=50'
DATE	5/14
DWG. BY	JDH
DESIGN BY	JDH
APPROVED	RWB




REVISIONS	


STATE	PROJECT NO.	SHEET NO.	TOTAL SHEETS
N.C.	45340.3.FRB	2C	
F.A. PROJECT NO.			

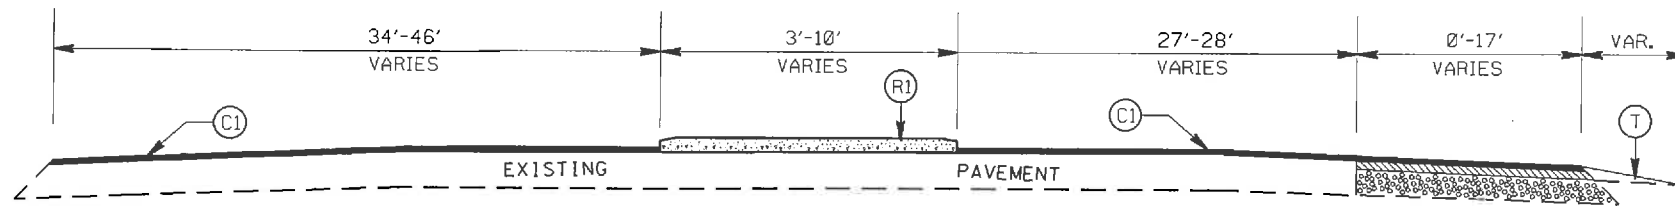

TYPICAL SECTION NO.12
STA 64+68.47 TO 64+93.89 -L-

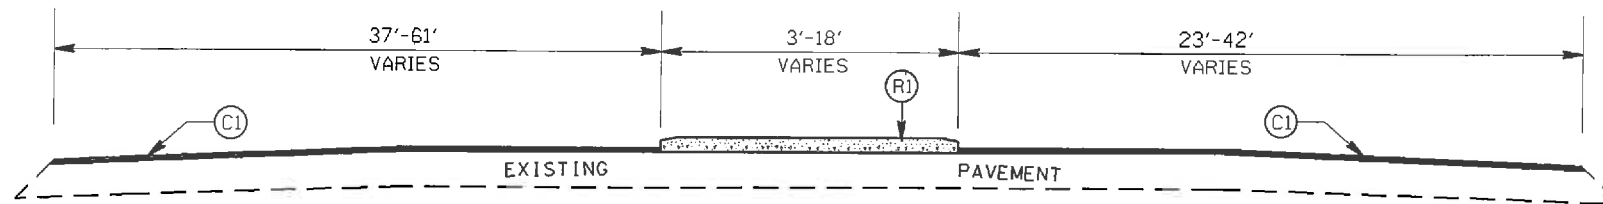

TYPICAL SECTION NO.11
STA 64+04.83 TO 64+68.47 -L-
STA 75+92.64 TO 78+42.64 -L-

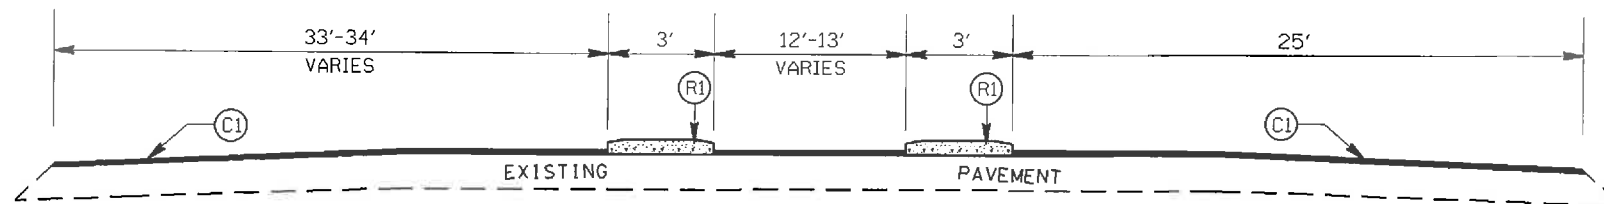

TYPICAL SECTION NO.10
STA 63+43.89 TO 64+04.83 -L-
STA 75+02.65 TO 75+92.64 -L-

PAVEMENT SCHEDULE

(C1)	PROP. APPROX. 1½" ASPHALT CONC. SURFACE COURSE, TYPE S9.5C, AT AN AVERAGE RATE OF 168 LBS. PER SQ. YD.
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(R5)	PROP. 4" CONCRETE SIDEWALK
(T)	EARTH MATERIAL
(V1)	MILLING ASPHALT PAVEMENT, 0" TO 1.5" IN DEPTH


US 29 FROM PAVILLION BLVD. TO
BRUTON SMITH BLVD.

SCALE	1"=50'
DATE	5/14
DWG. BY	JDH
DESIGN BY	JDH
APPROVED	RWB




REVISIONS	

STATE	PROJECT NO.	SHEET NO.	TOTAL SHEETS
N.C.	45340.3.FR8	2D	
F.A. PROJECT NO.			

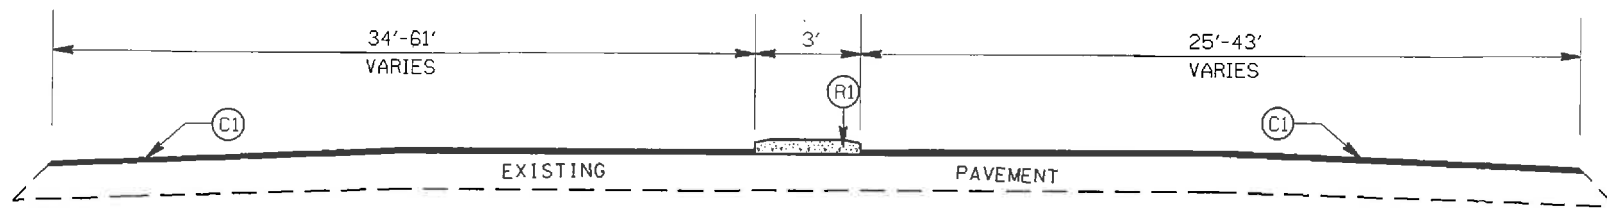


TYPICAL SECTION NO.15

STA 62+43.86 TO 63+43.89 -L-
 STA 65+94.43 TO 66+54.79 -L-
 STA 71+63.57 TO 75+02.65 -L-

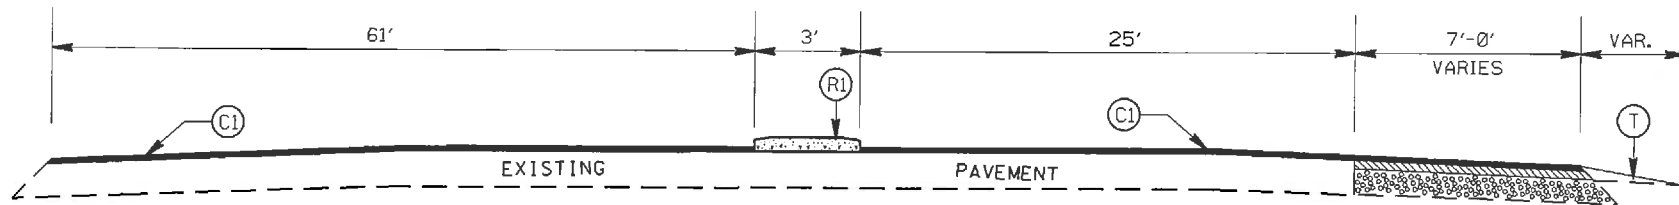

TYPICAL SECTION NO.14

STA 65+54.83 TO 65+94.43 -L-

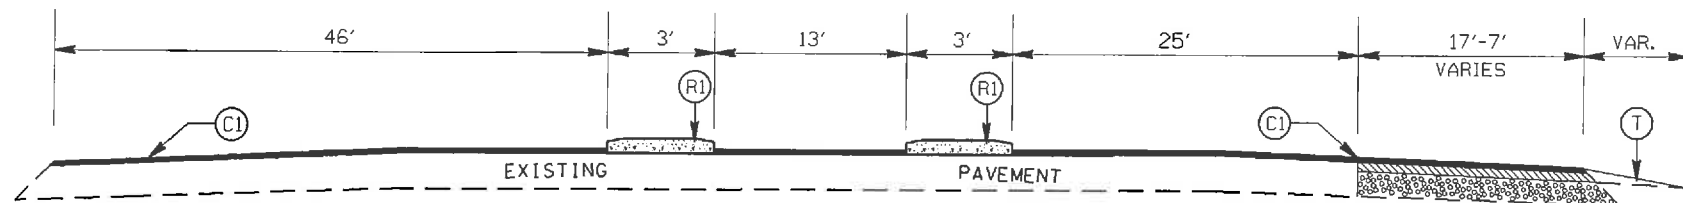

TYPICAL SECTION NO.13

STA 64+93.89 TO 65+54.83 -L-

PAVEMENT SCHEDULE

(C1)	PROP. APPROX. 1½" ASPHALT CONC. SURFACE COURSE, TYPE S9.5C, AT AN AVERAGE RATE OF 168 LBS. PER SQ. YD.
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(R5)	PROP. 4" CONCRETE SIDEWALK
(T)	EARTH MATERIAL
(V1)	MILLING ASPHALT PAVEMENT, 0' TO 1.5' IN DEPTH


US 29 FROM PAVILLION BLVD. TO
 BRUTON SMITH BLVD.

SCALE	1"=50'
DATE	5/14
DWG. BY	JDH
DESIGN BY	JDH
APPROVED	RWB




REVISIONS	


STATE	PROJECT NO.	SHEET NO.	TOTAL SHEETS
N.C.	45340.3.FRB	2E	
F.A. PROJECT NO.			

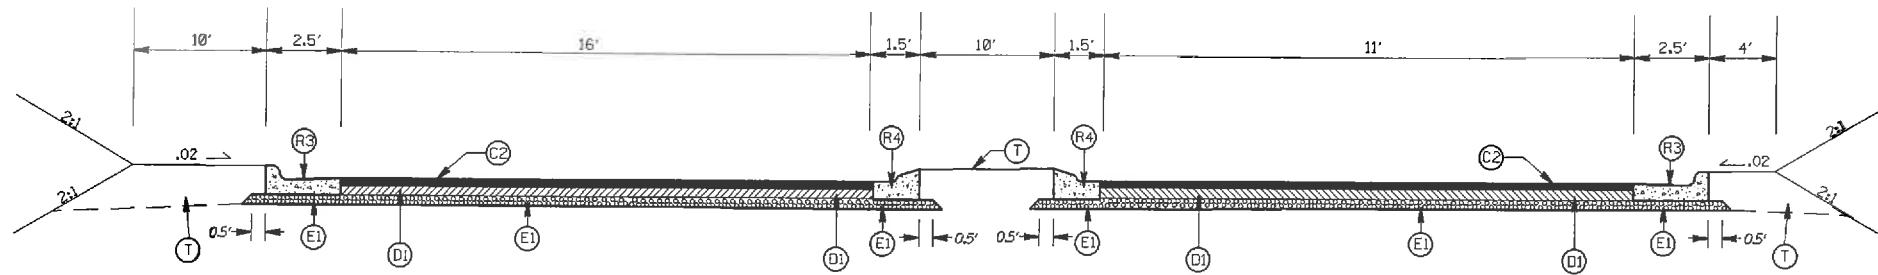

TYPICAL SECTION NO. 18
 STA 11+88.30 TO 12+54.20 -Y2-
 PAVILLION VILLAGE DRIVE.

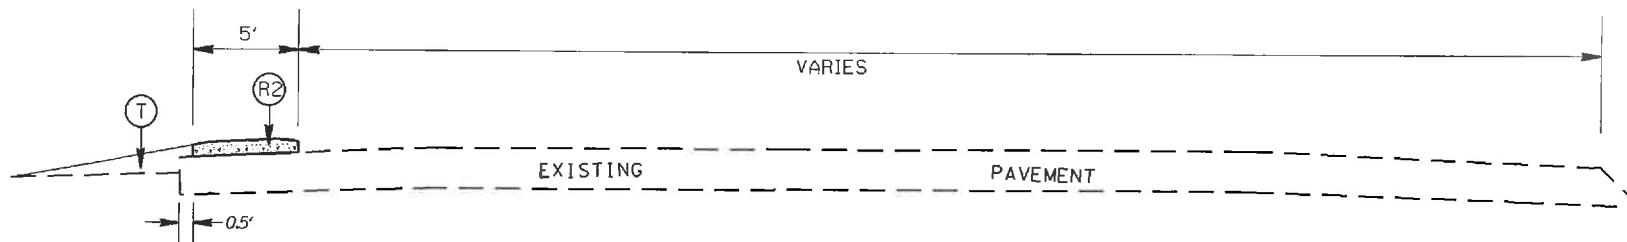

TYPICAL SECTION NO. 17
 STA 10+28.82 TO 12+17.45 -Y-

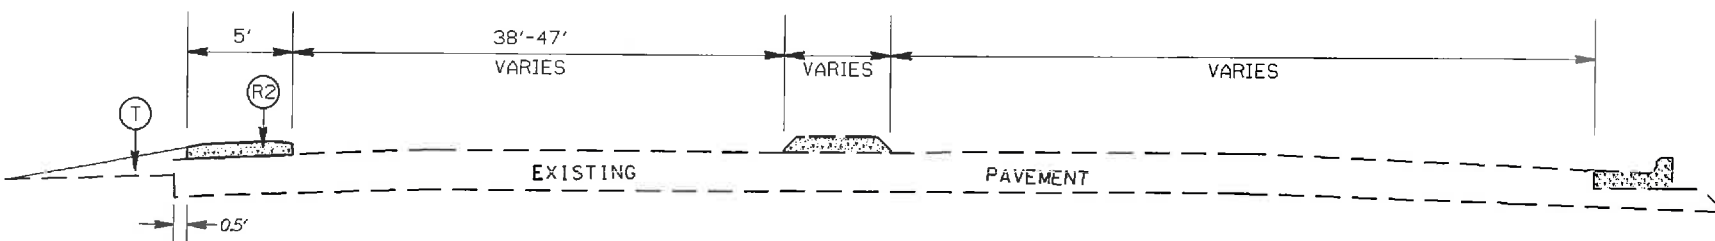

TYPICAL SECTION NO. 16
 STA 117+73.31 TO 118+86.49 -L-

PAVEMENT SCHEDULE

(C1)	PROP. APPROX. 1½" ASPHALT CONC. SURFACE COURSE, TYPE S9.5C, AT AN AVERAGE RATE OF 168 LBS. PER SQ. YD.
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(T)	EARTH MATERIAL
(V1)	MILLING ASPHALT PAVEMENT, 0' TO 1.5' IN DEPTH

US 29 FROM PAVILLION BLVD. TO
 BRUTON SMITH BLVD.

SCALE	1"=50'
DATE	5/14
DWG. BY	JDH
DESIGN BY	JDH
APPROVED	RWB




REVISIONS	

STATE	PROJECT NO.	SHEET NO.	TOTAL SHEETS
N.C.	45340,3,FR8	2F	
F.A. PROJECT NO.			

PAVEMENT SCHEDULE

(C1)	PROP. APPROX. 1½" ASPHALT CONC. SURFACE COURSE, TYPE S9.5C, AT AN AVERAGE RATE OF 168 LBS. PER SQ. YD.
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(R5)	PROP. 4" CONCRETE SIDEWALK
(T)	EARTH MATERIAL
(V1)	MILLING ASPHALT PAVEMENT, 0" TO 1.5" IN DEPTH

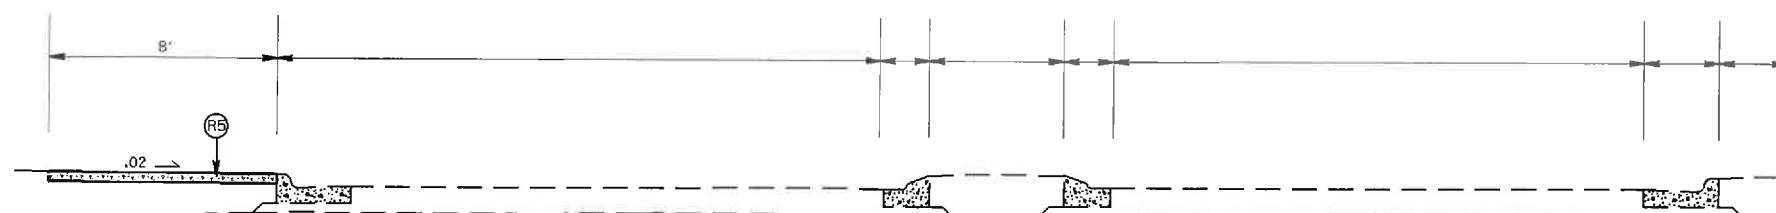

TYPICAL SECTION NO. 19
MOREHEAD ROAD

US 29 FROM PAVILLION BLVD. TO
BRUTON SMITH BLVD.


SCALE	1"=50'
DATE	5/14
DWG. BY	JDH
DESIGN BY	JDH
APPROVED	RWB




REVISIONS	

STATE	PROJECT NO.	SHEET NO.	TOTAL SHEETS
N.C.	45340.3,FR8	26	
F.A. PROJECT NO.			

MEDIAN PIPE INSTALLATION

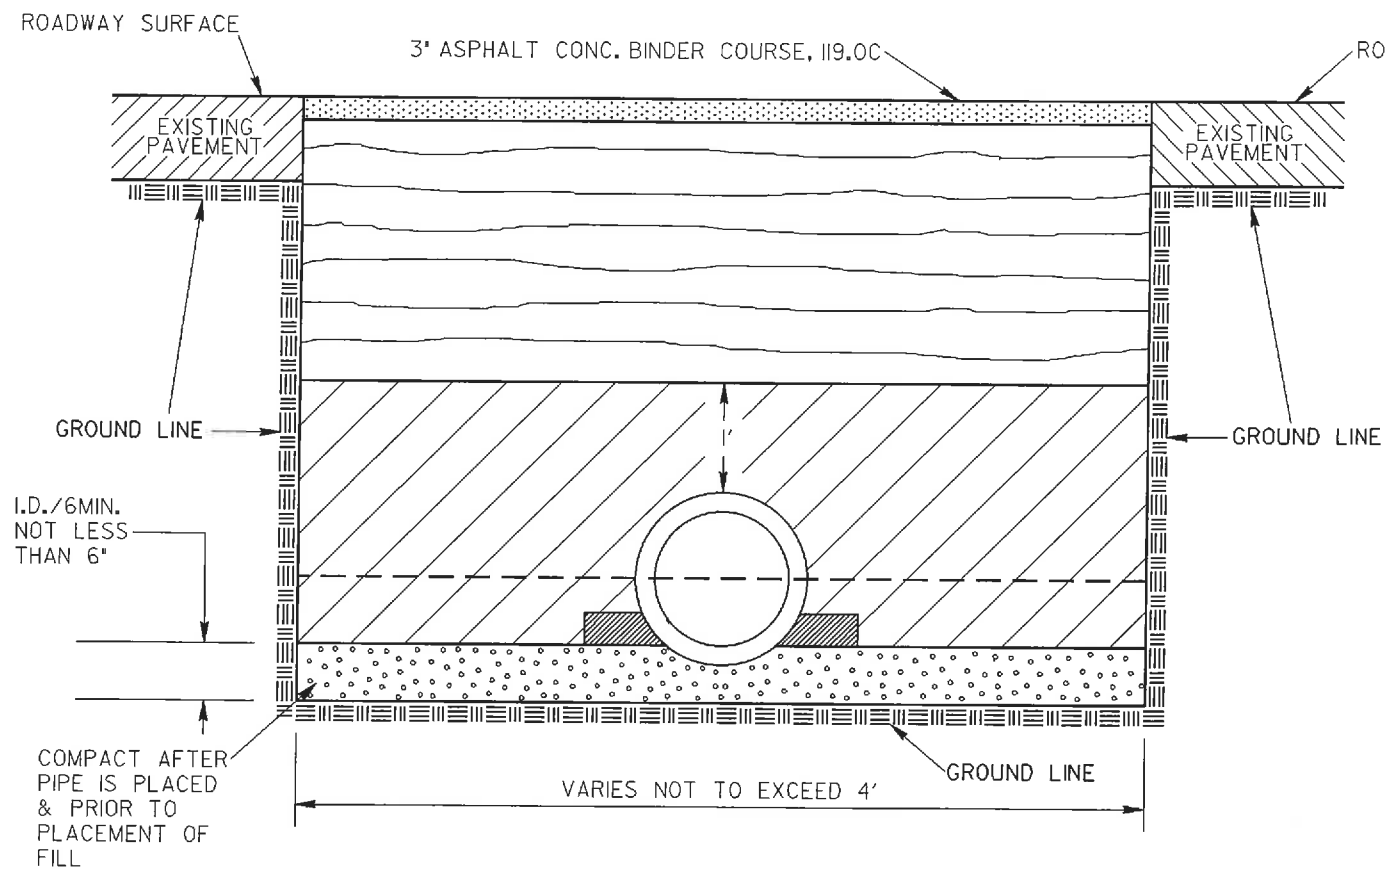




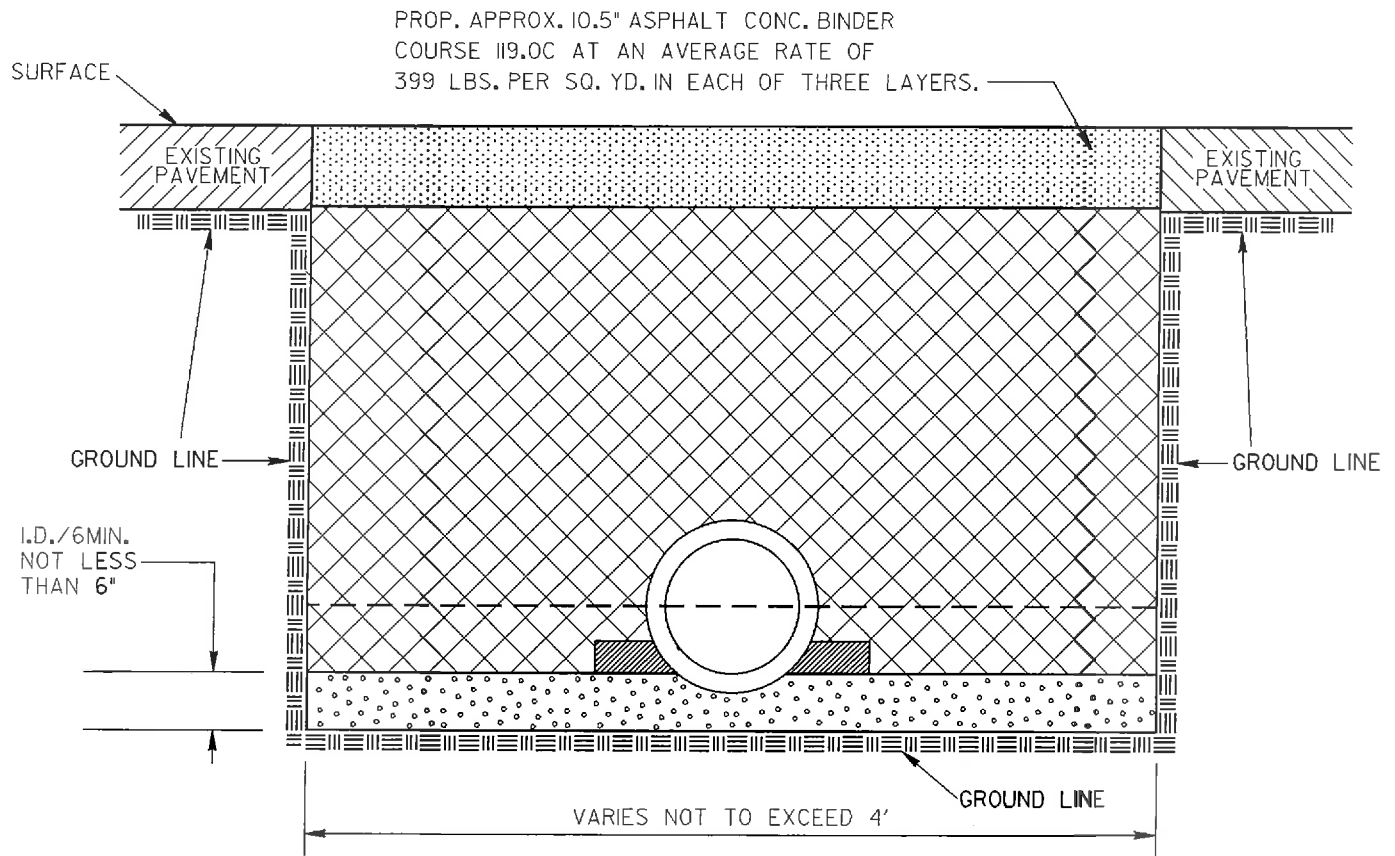



CROSSLINE PIPE INSTALLATION



NORMAL EARTH FOUNDATION

NORMAL EARTH FOUNDATION

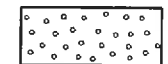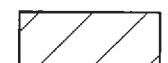
GENERAL NOTES:

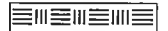-  SPRINGLINE OF PIPE
-  TAKE CARE TO FULLY COMPACT HAUNCH ZONE OF PIPE BACKFILL
-  LOOSELY PLACED SELECT MATERIAL CLASS III OR CLASS II, TYPE I FOR PIPE BEDDING. LEAVE SECTION DIRECTLY BENEATH PIPE UNCOMPACTED AS PIPE SEATING AND BACKFILL WILL ACCOMPLISH COMPACTION.
-  SELECT BACKFILL MATERIAL CLASS III OR CLASS II, TYPE I ABOVE AND BELOW SPRINGLINE.
-  APPROVED SUITABLE LOCAL MATERIAL.
-  SELECT GRANULAR MATERIAL CLASS II, TYPE I.
-  UNDISTURBED EARTH MATERIAL

US 29 FROM PAVILLION BLVD. TO
BRUTON SMITH BLVD.

SCALE	1"=50'		REVISIONS	
DATE	5/14			
DWG. BY	JDH			
DESIGN BY	JDH			
APPROVED	RWB			

STATE	PROJECT NO.	SHEET NO.	TOTAL SHEETS
N.C.	45340.3FRB	4	
F.A. PROJECT NO. HSIP-002960			

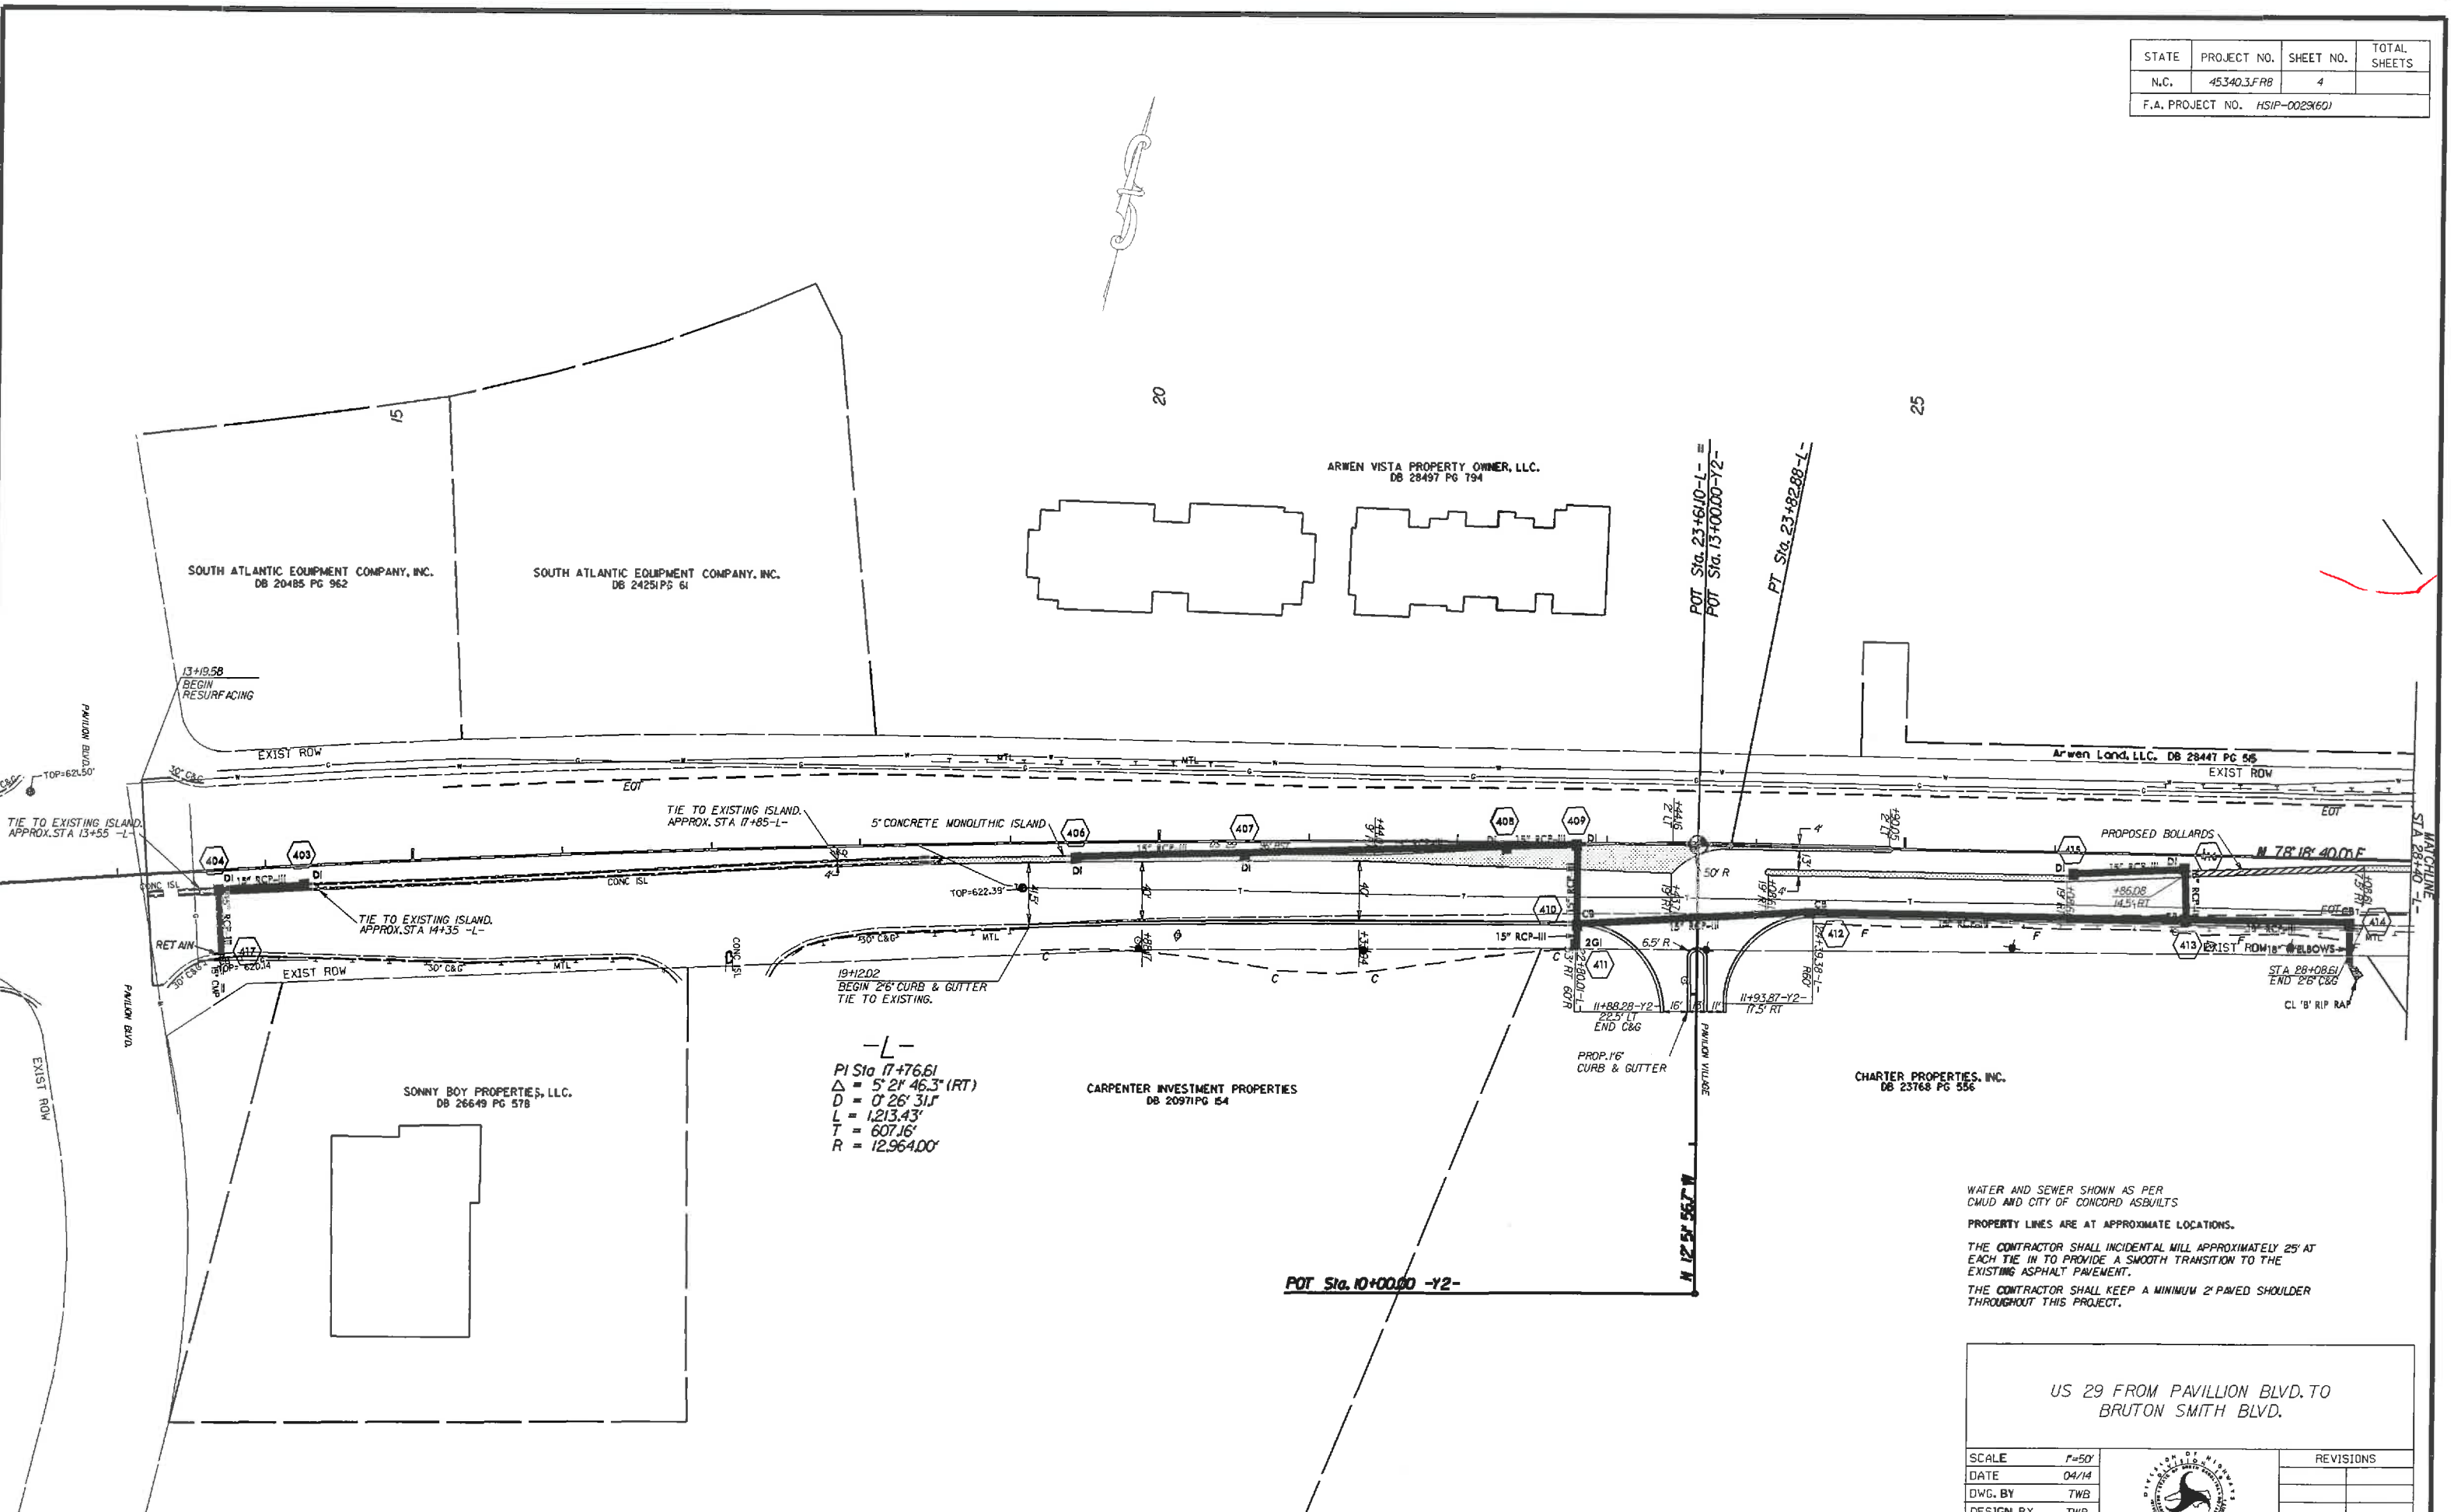

-L-
 PI Sta 17+76.61
 $\Delta = 5' 21" 46.3" (RT)$
 $D = 0' 26' 31"$
 $L = 1,213.43'$
 $T = 607.16'$
 $R = 12,964.00'$

WATER AND SEWER SHOWN AS PER
 CMUD AND CITY OF CONCORD ASBUILTS

PROPERTY LINES ARE AT APPROXIMATE LOCATIONS.


THE CONTRACTOR SHALL INCIDENTAL WILL APPROXIMATELY 25' AT
 EACH TIE IN TO PROVIDE A SMOOTH TRANSITION TO THE
 EXISTING ASPHALT PAVEMENT.

THE CONTRACTOR SHALL KEEP A MINIMUM 2' PAVED SHOULDER
 THROUGHOUT THIS PROJECT.

US 29 FROM PAVILLION BLVD. TO
 BRUTON SMITH BLVD.

SCALE	1"=50'		REVISIONS
DATE	04/14		
DWG. BY	TWB		
DESIGN BY	TWB		
APPROVED	RWB		

STATE	PROJECT NO.	SHEET NO.	TOTAL SHEETS
N.C.	45340.3.FRB	5	
F.A. PROJECT NO. HSIP-0029601			

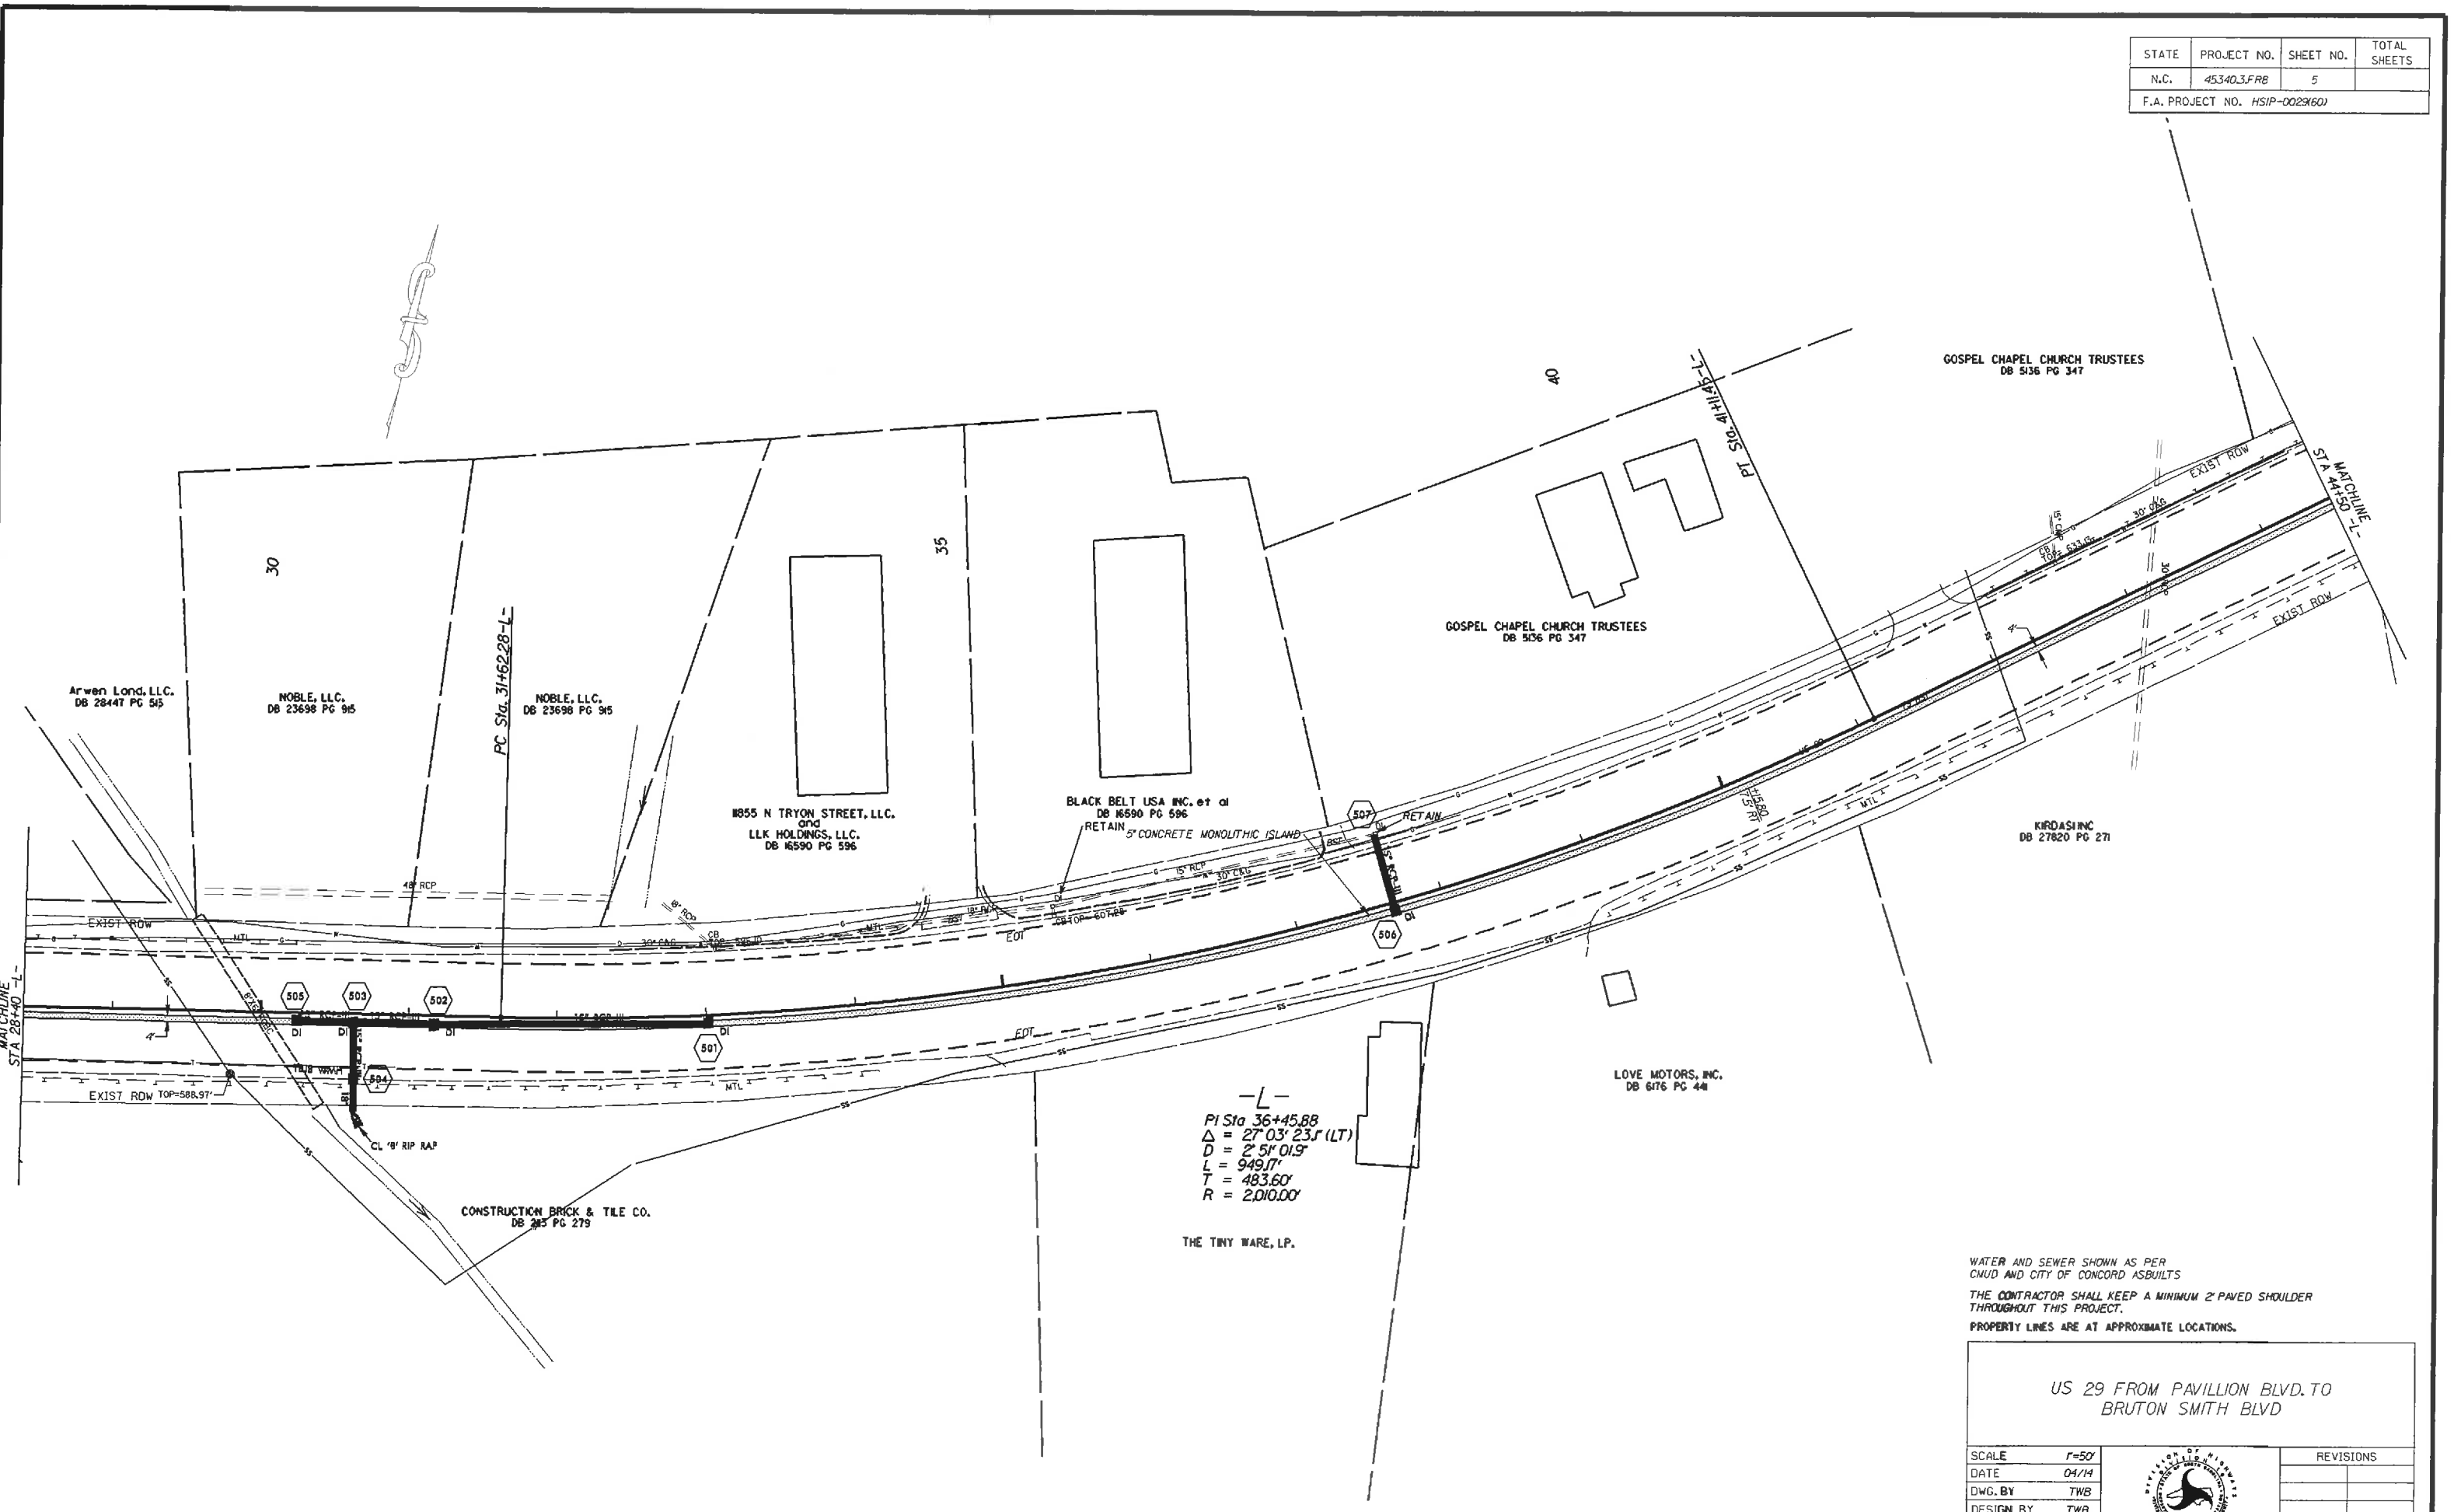


-L-
 PI Sta 36+45.88
 $\Delta = 27^{\circ} 03' 23''$ (LT)
 $D = 2' 51' 01.9''$
 $L = 949.17'$
 $T = 483.60'$
 $R = 2,010.00'$

WATER AND SEWER SHOWN AS PER
 CMUD AND CITY OF CONCORD ASUILTS
 THE CONTRACTOR SHALL KEEP A MINIMUM 2' PAVED SHOULDER
 THROUGHOUT THIS PROJECT.
 PROPERTY LINES ARE AT APPROXIMATE LOCATIONS.

US 29 FROM PAVILLION BLVD. TO
BRUTON SMITH BLVD

SCALE	1"=50'		REVISIONS
DATE	04/14		
DWG. BY	TWB		
DESIGN BY	TWB		
APPROVED	RWB		

STATE	PROJECT NO.	SHEET NO.	TOTAL SHEETS
N.C.	45340.3.FRB	6	
F.A. PROJECT NO.		HSIP-0029(60)	

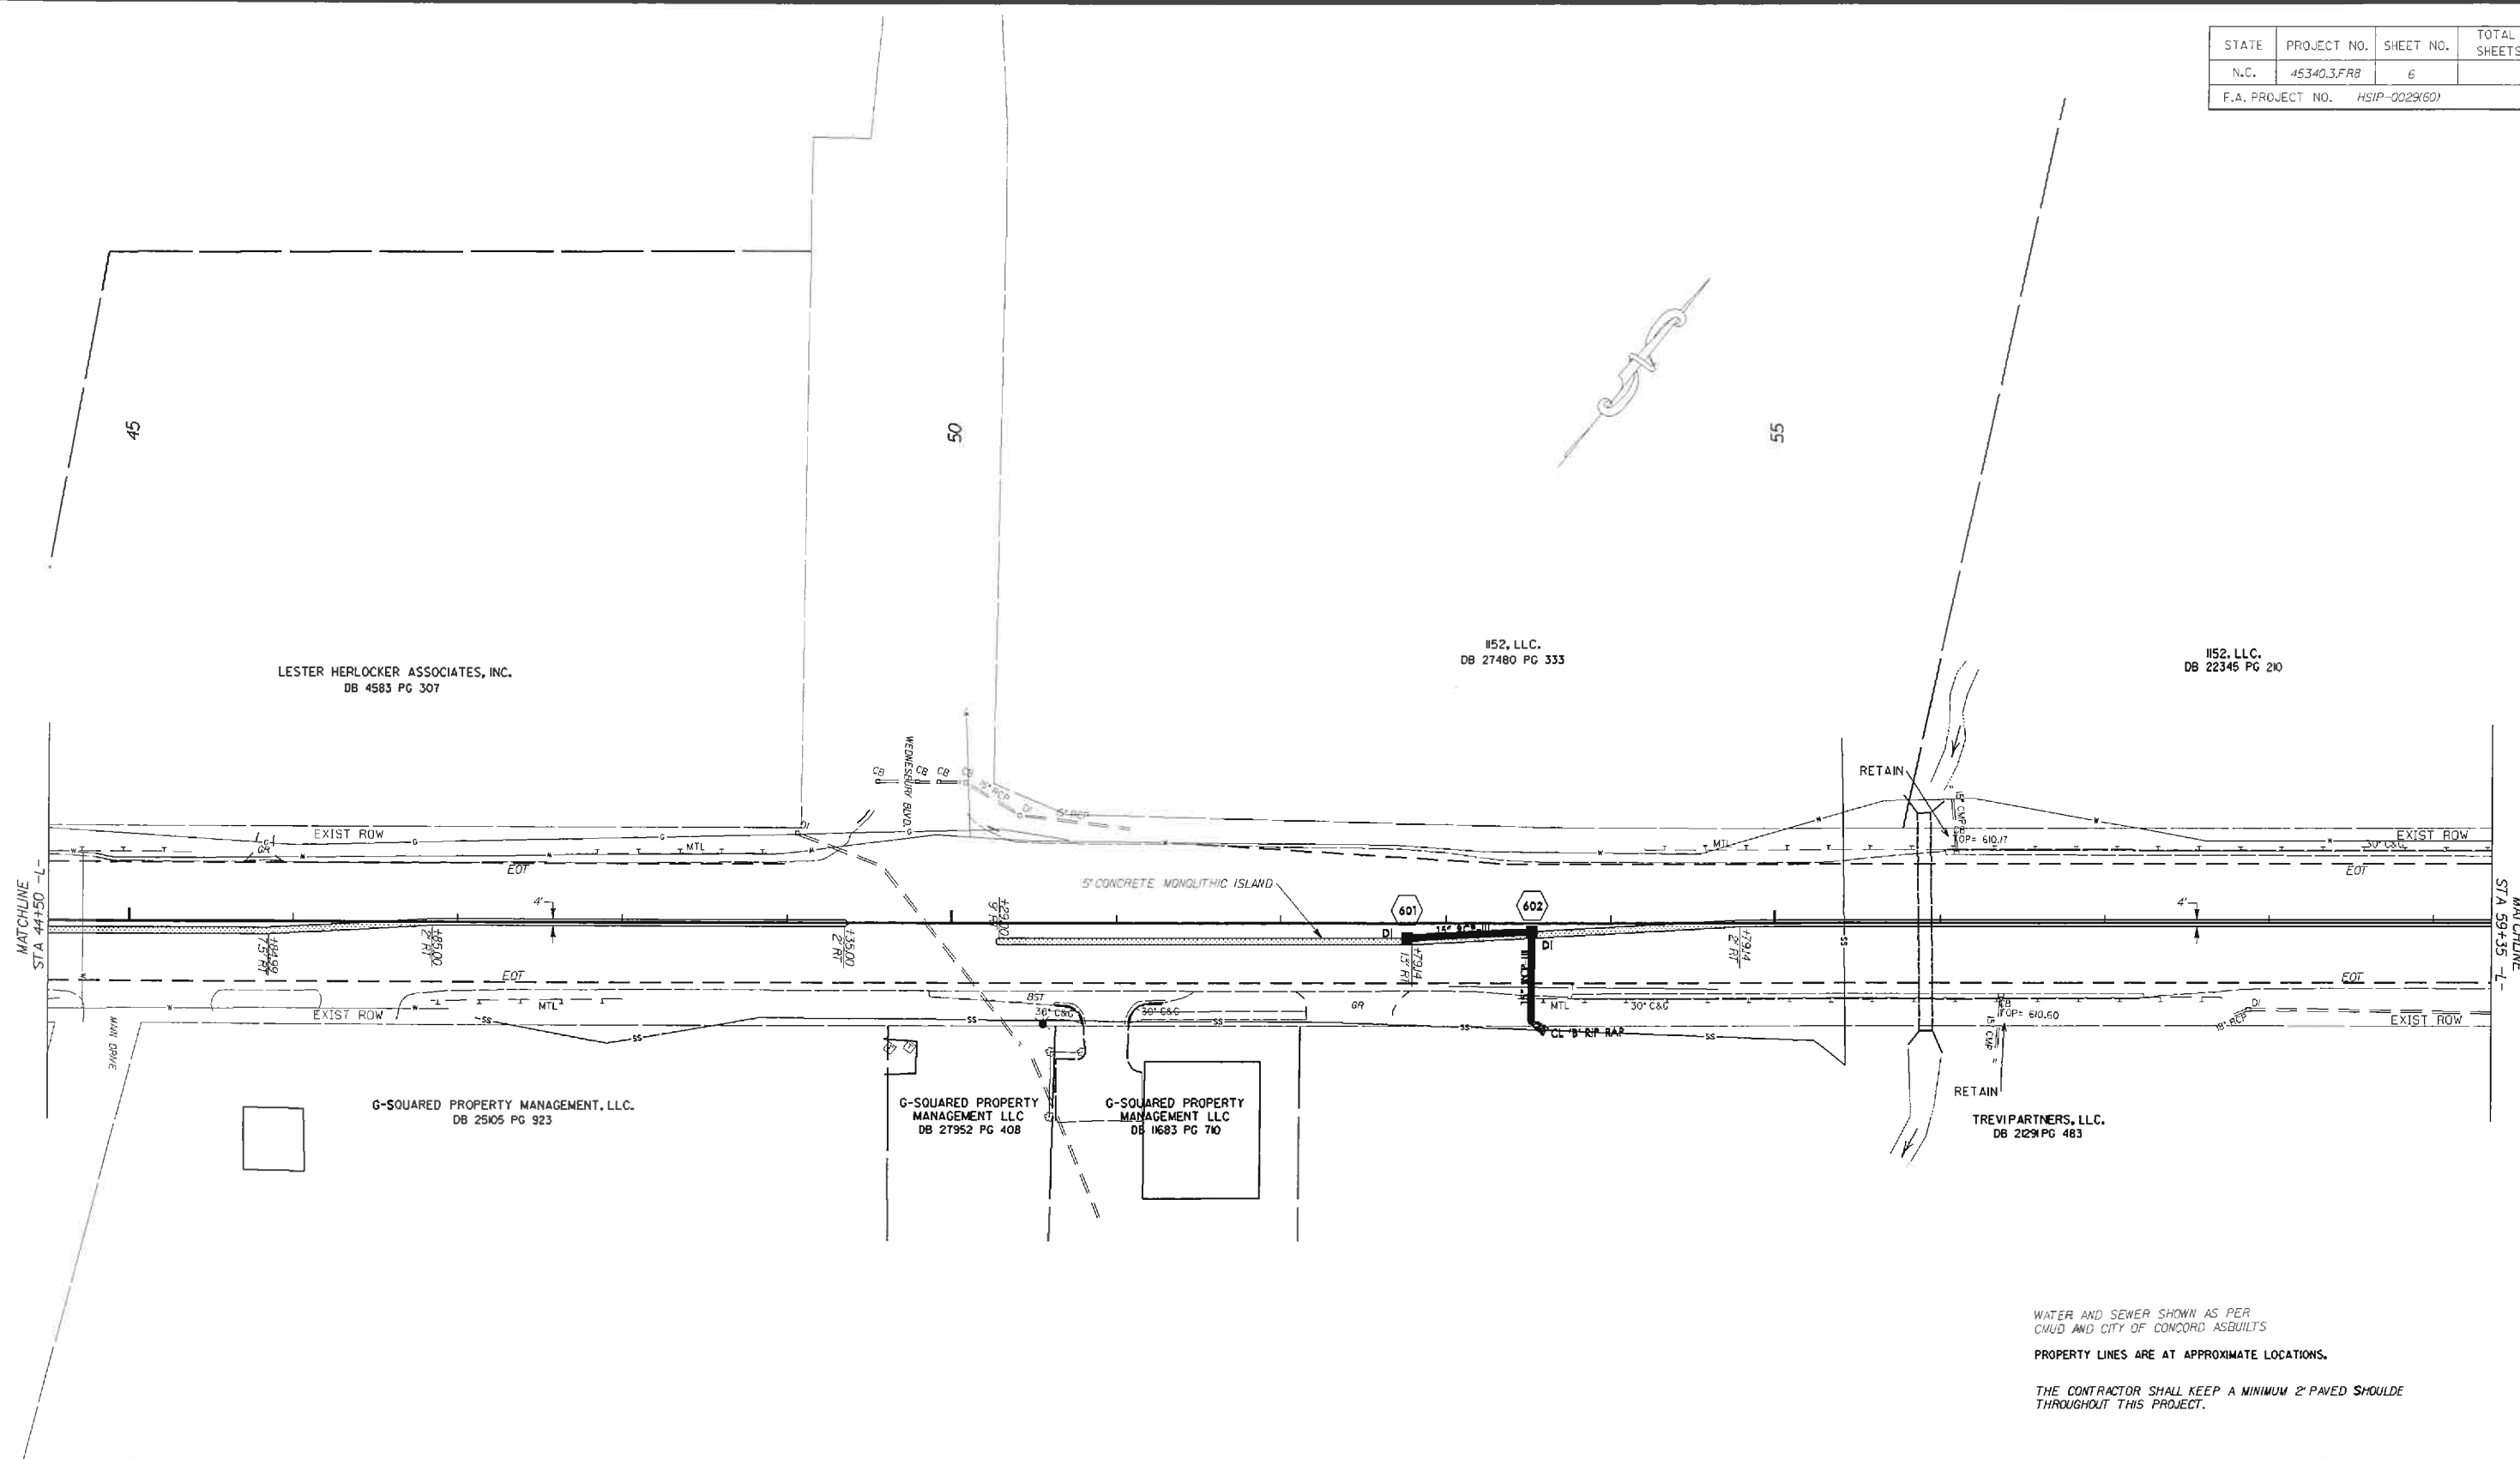


WATER AND SEWER SHOWN AS PER
 CMUD AND CITY OF CONCORD ASBUILTS
 PROPERTY LINES ARE AT APPROXIMATE LOCATIONS.
 THE CONTRACTOR SHALL KEEP A MINIMUM 2' PAVED SHOULDER
 THROUGHOUT THIS PROJECT.

US 29 FROM PAVILLION BLVD. TO
 BRUTON SMITH BLVD

SCALE	1"=50'		REVISIONS
DATE	04/14		
DWG. BY	TWB		
DESIGN BY	TWB		
APPROVED	RWB		

STATE	PROJECT NO.	SHEET NO.	TOTAL SHEETS
N.C.	45340.3.FRB	7	
F.A. PROJECT NO. HSIP-002960			

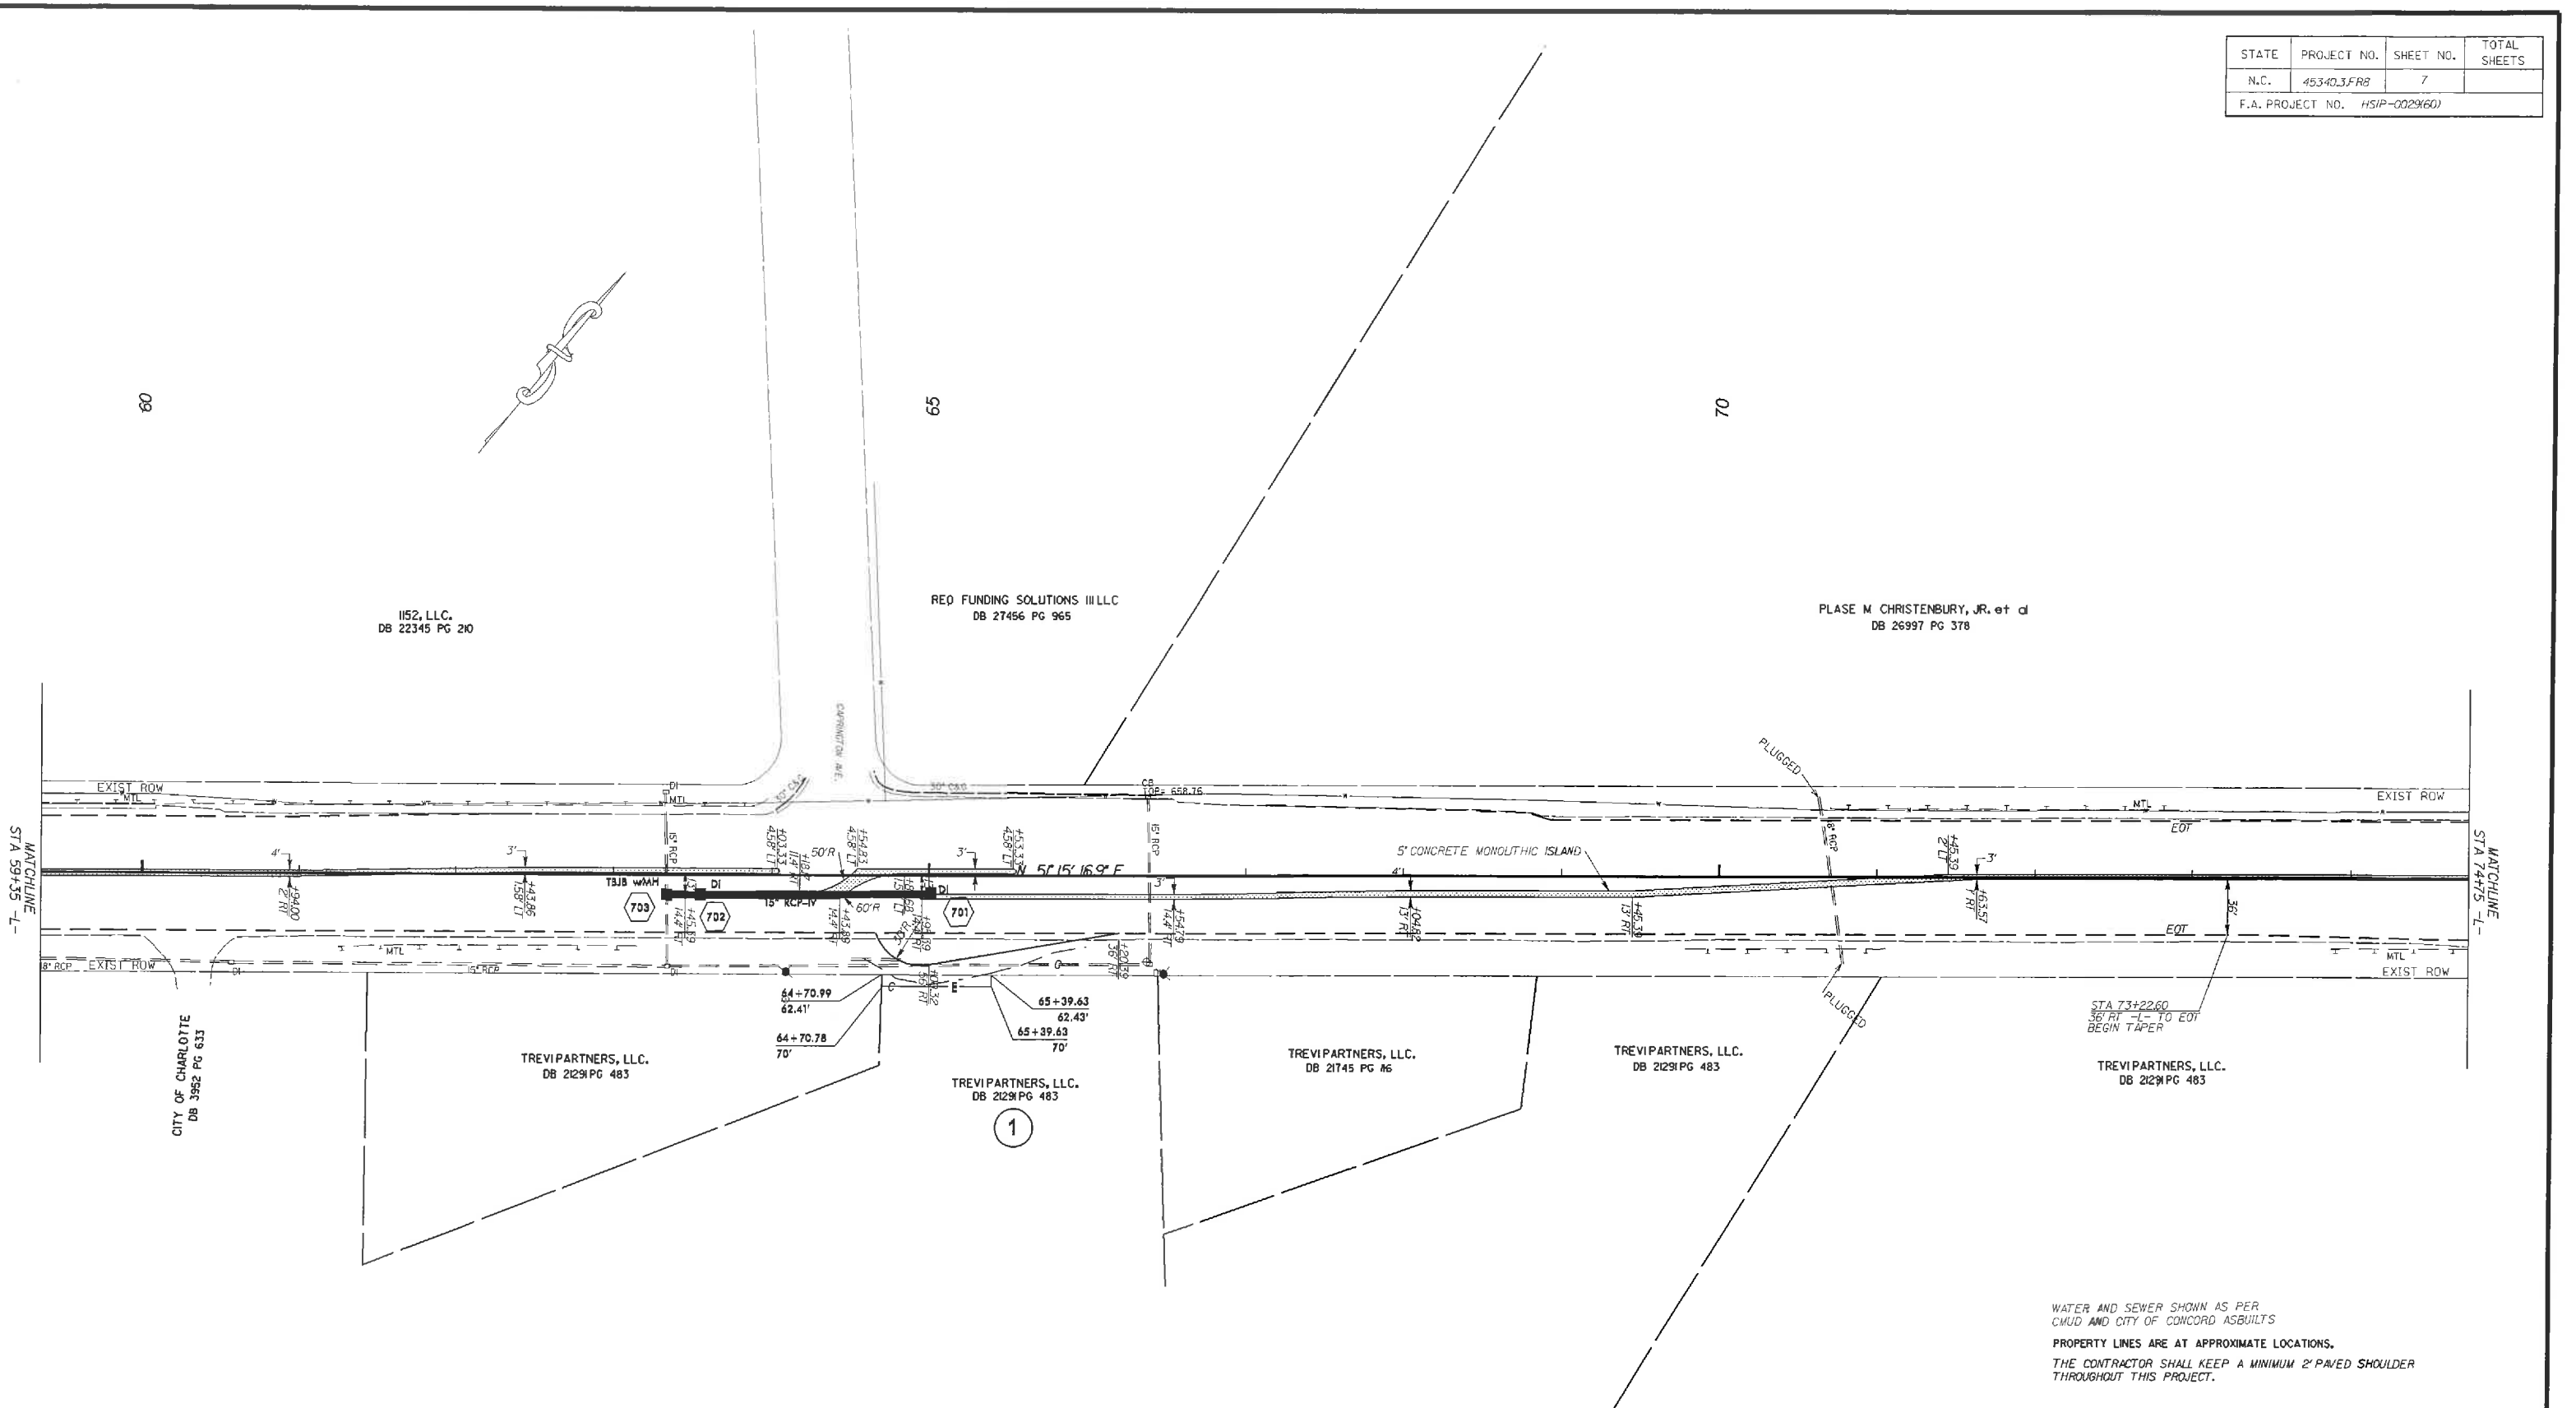


WATER AND SEWER SHOWN AS PER
 CMUD AND CITY OF CONCORD ASBUILTS
 PROPERTY LINES ARE AT APPROXIMATE LOCATIONS.
 THE CONTRACTOR SHALL KEEP A MINIMUM 2' PAVED SHOULDER
 THROUGHOUT THIS PROJECT.

PARCEL NO.	PARCEL OWNER	TOTAL ACREAGE	AREA TAKEN	AREA REMAINING	TEMP. CONST. EASE.	PERM. DRAIN. EASE.
1	TREVI PARTNERS, LLC.	N/A	N/A	N/A	521 S.F.	N/A

US 29 FROM PAVILLION BLVD. TO
BRUTON SMITH BLVD


SCALE	1"=50'		REVISIONS
DATE	04/14		
DWG. BY	TWB		
DESIGN BY	TWB		
APPROVED	RWB		

STATE	PROJECT NO.	SHEET NO.	TOTAL SHEETS
N.C.	45340.3.FRB	8	
F.A. PROJECT NO.		HSIP-002960	

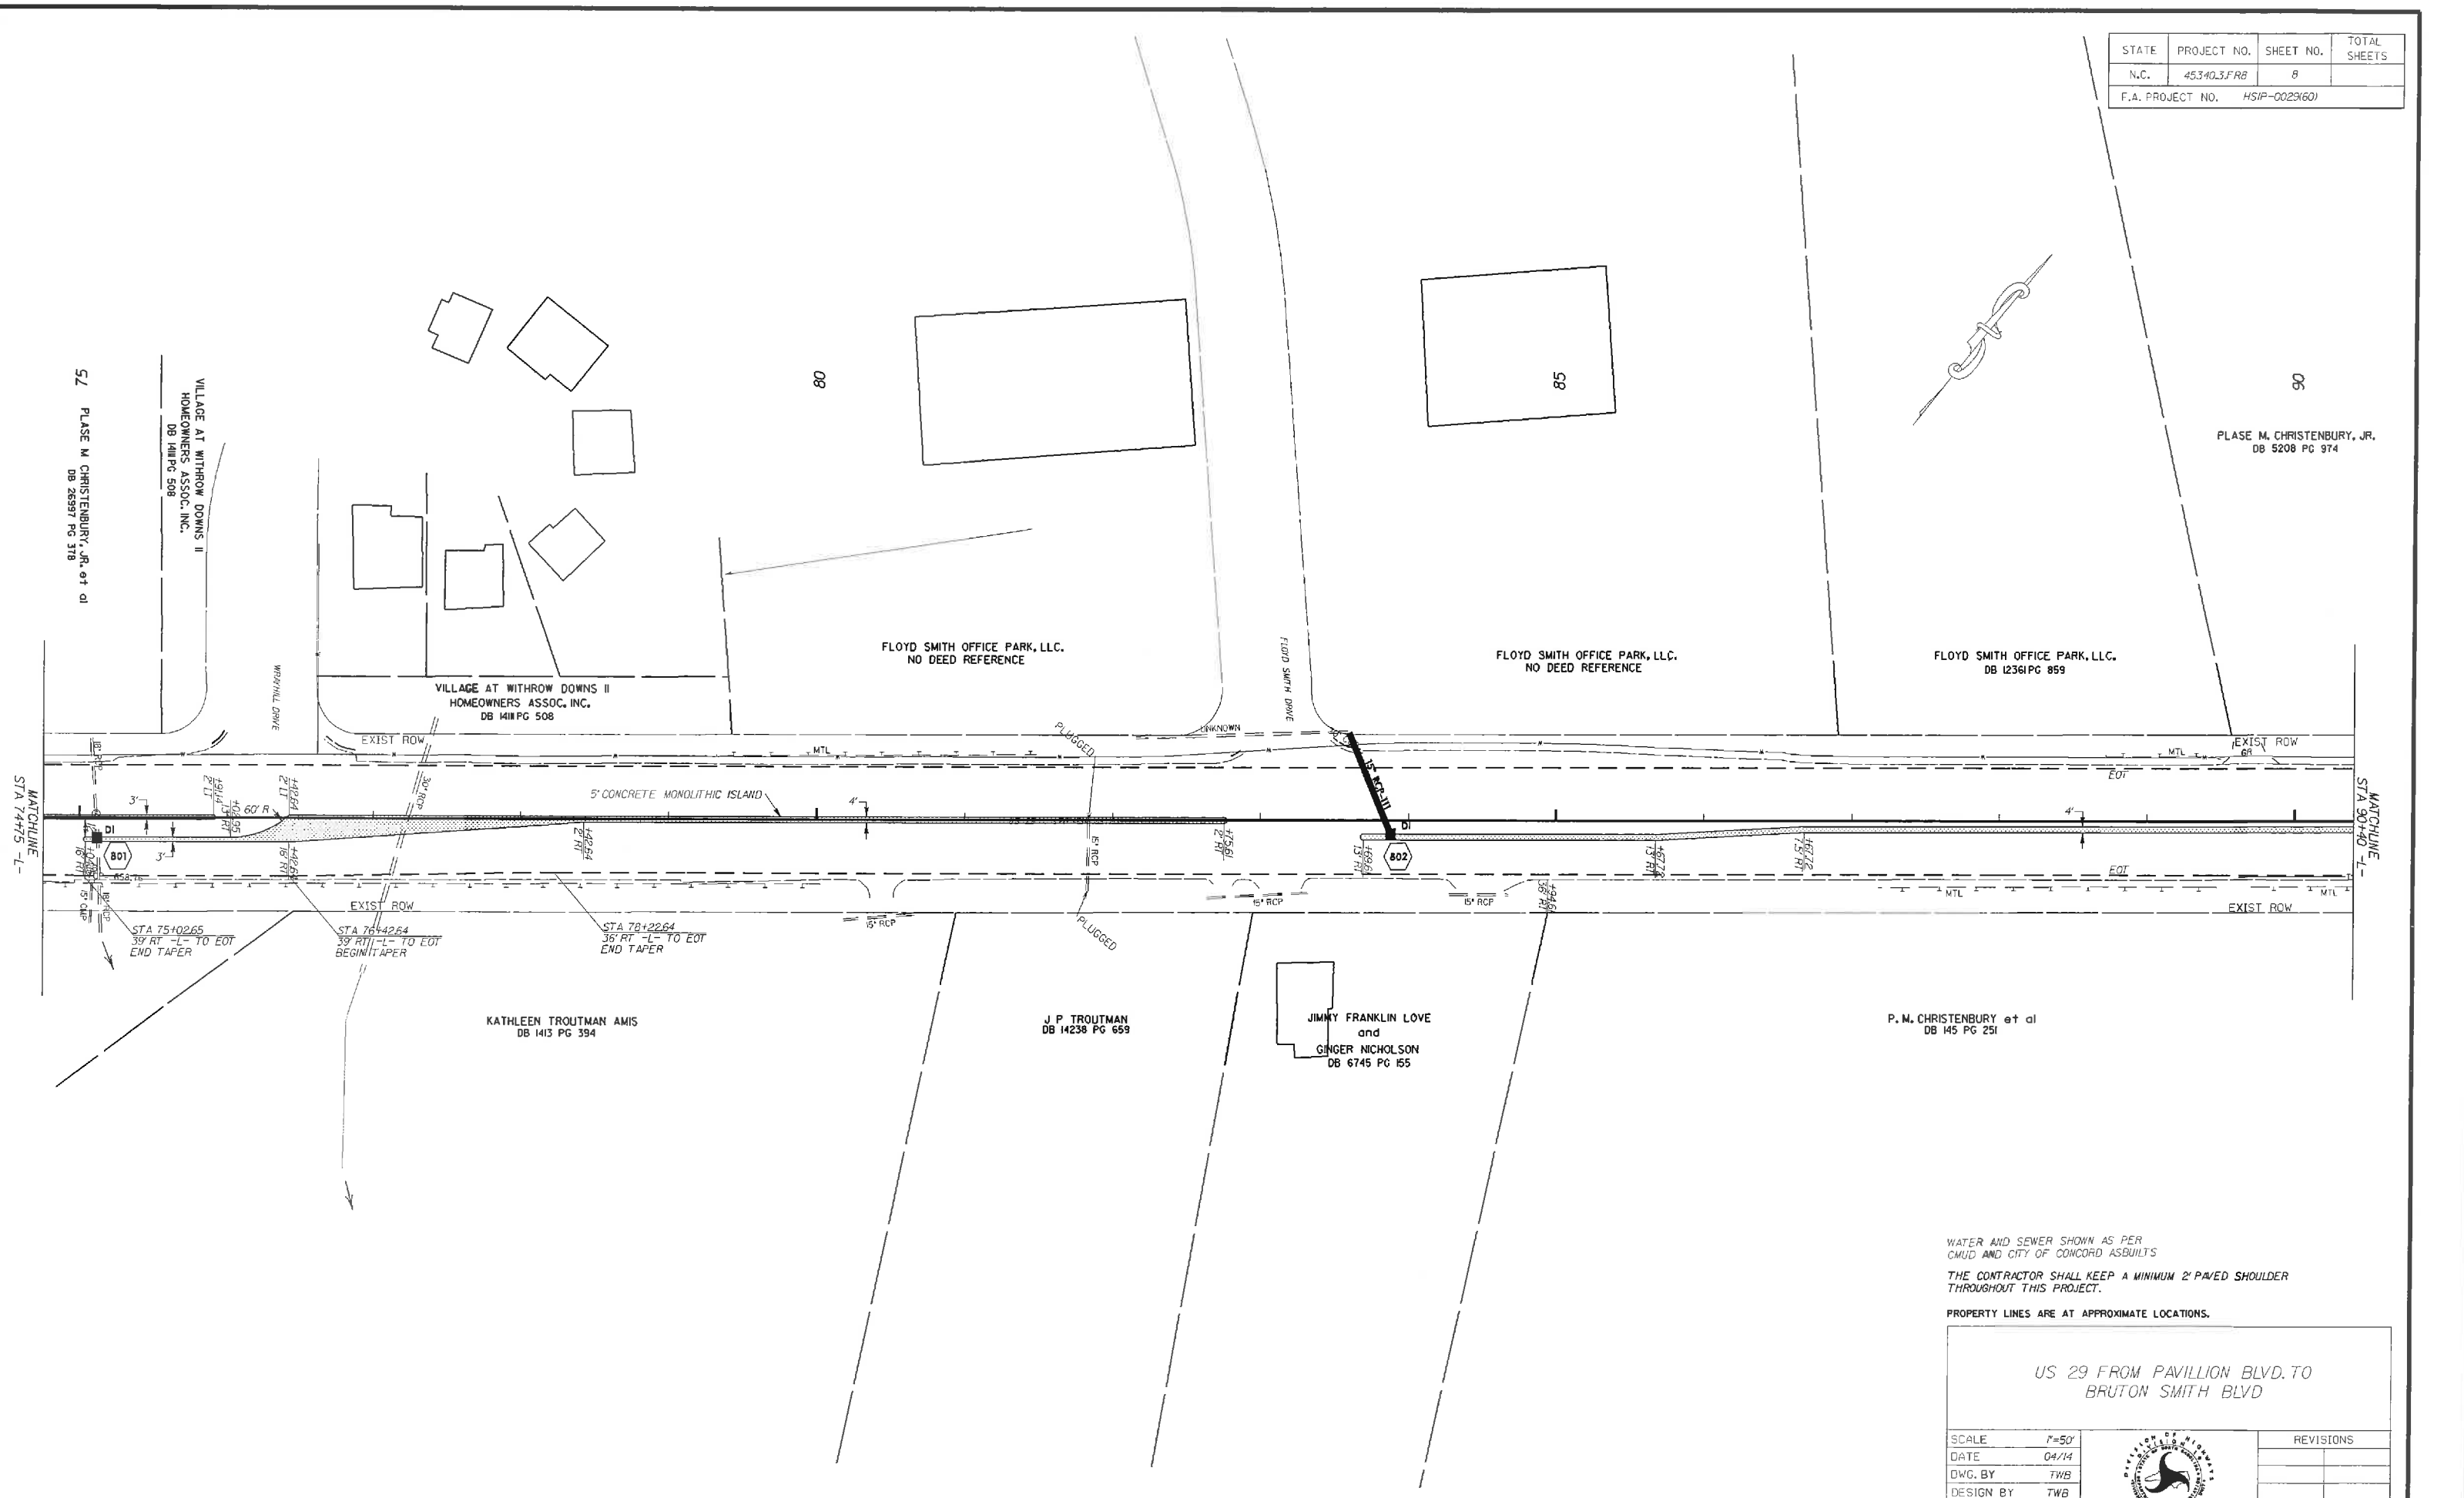


WATER AND SEWER SHOWN AS PER
 CMUD AND CITY OF CONCORD ASBUILTS
 THE CONTRACTOR SHALL KEEP A MINIMUM 2' PAVED SHOULDER
 THROUGHOUT THIS PROJECT.
 PROPERTY LINES ARE AT APPROXIMATE LOCATIONS.

US 29 FROM PAVILLION BLVD. TO
 BRUTON SMITH BLVD

SCALE	1"=50'		REVISIONS
DATE	04/14		
DWG. BY	TWB		
DESIGN BY	TWB		
APPROVED	RWB		

STATE	PROJECT NO.	SHEET NO.	TOTAL SHEETS
N.C.	45340.3.FRB	9	
F.A. PROJECT NO.		HSIP-002960	

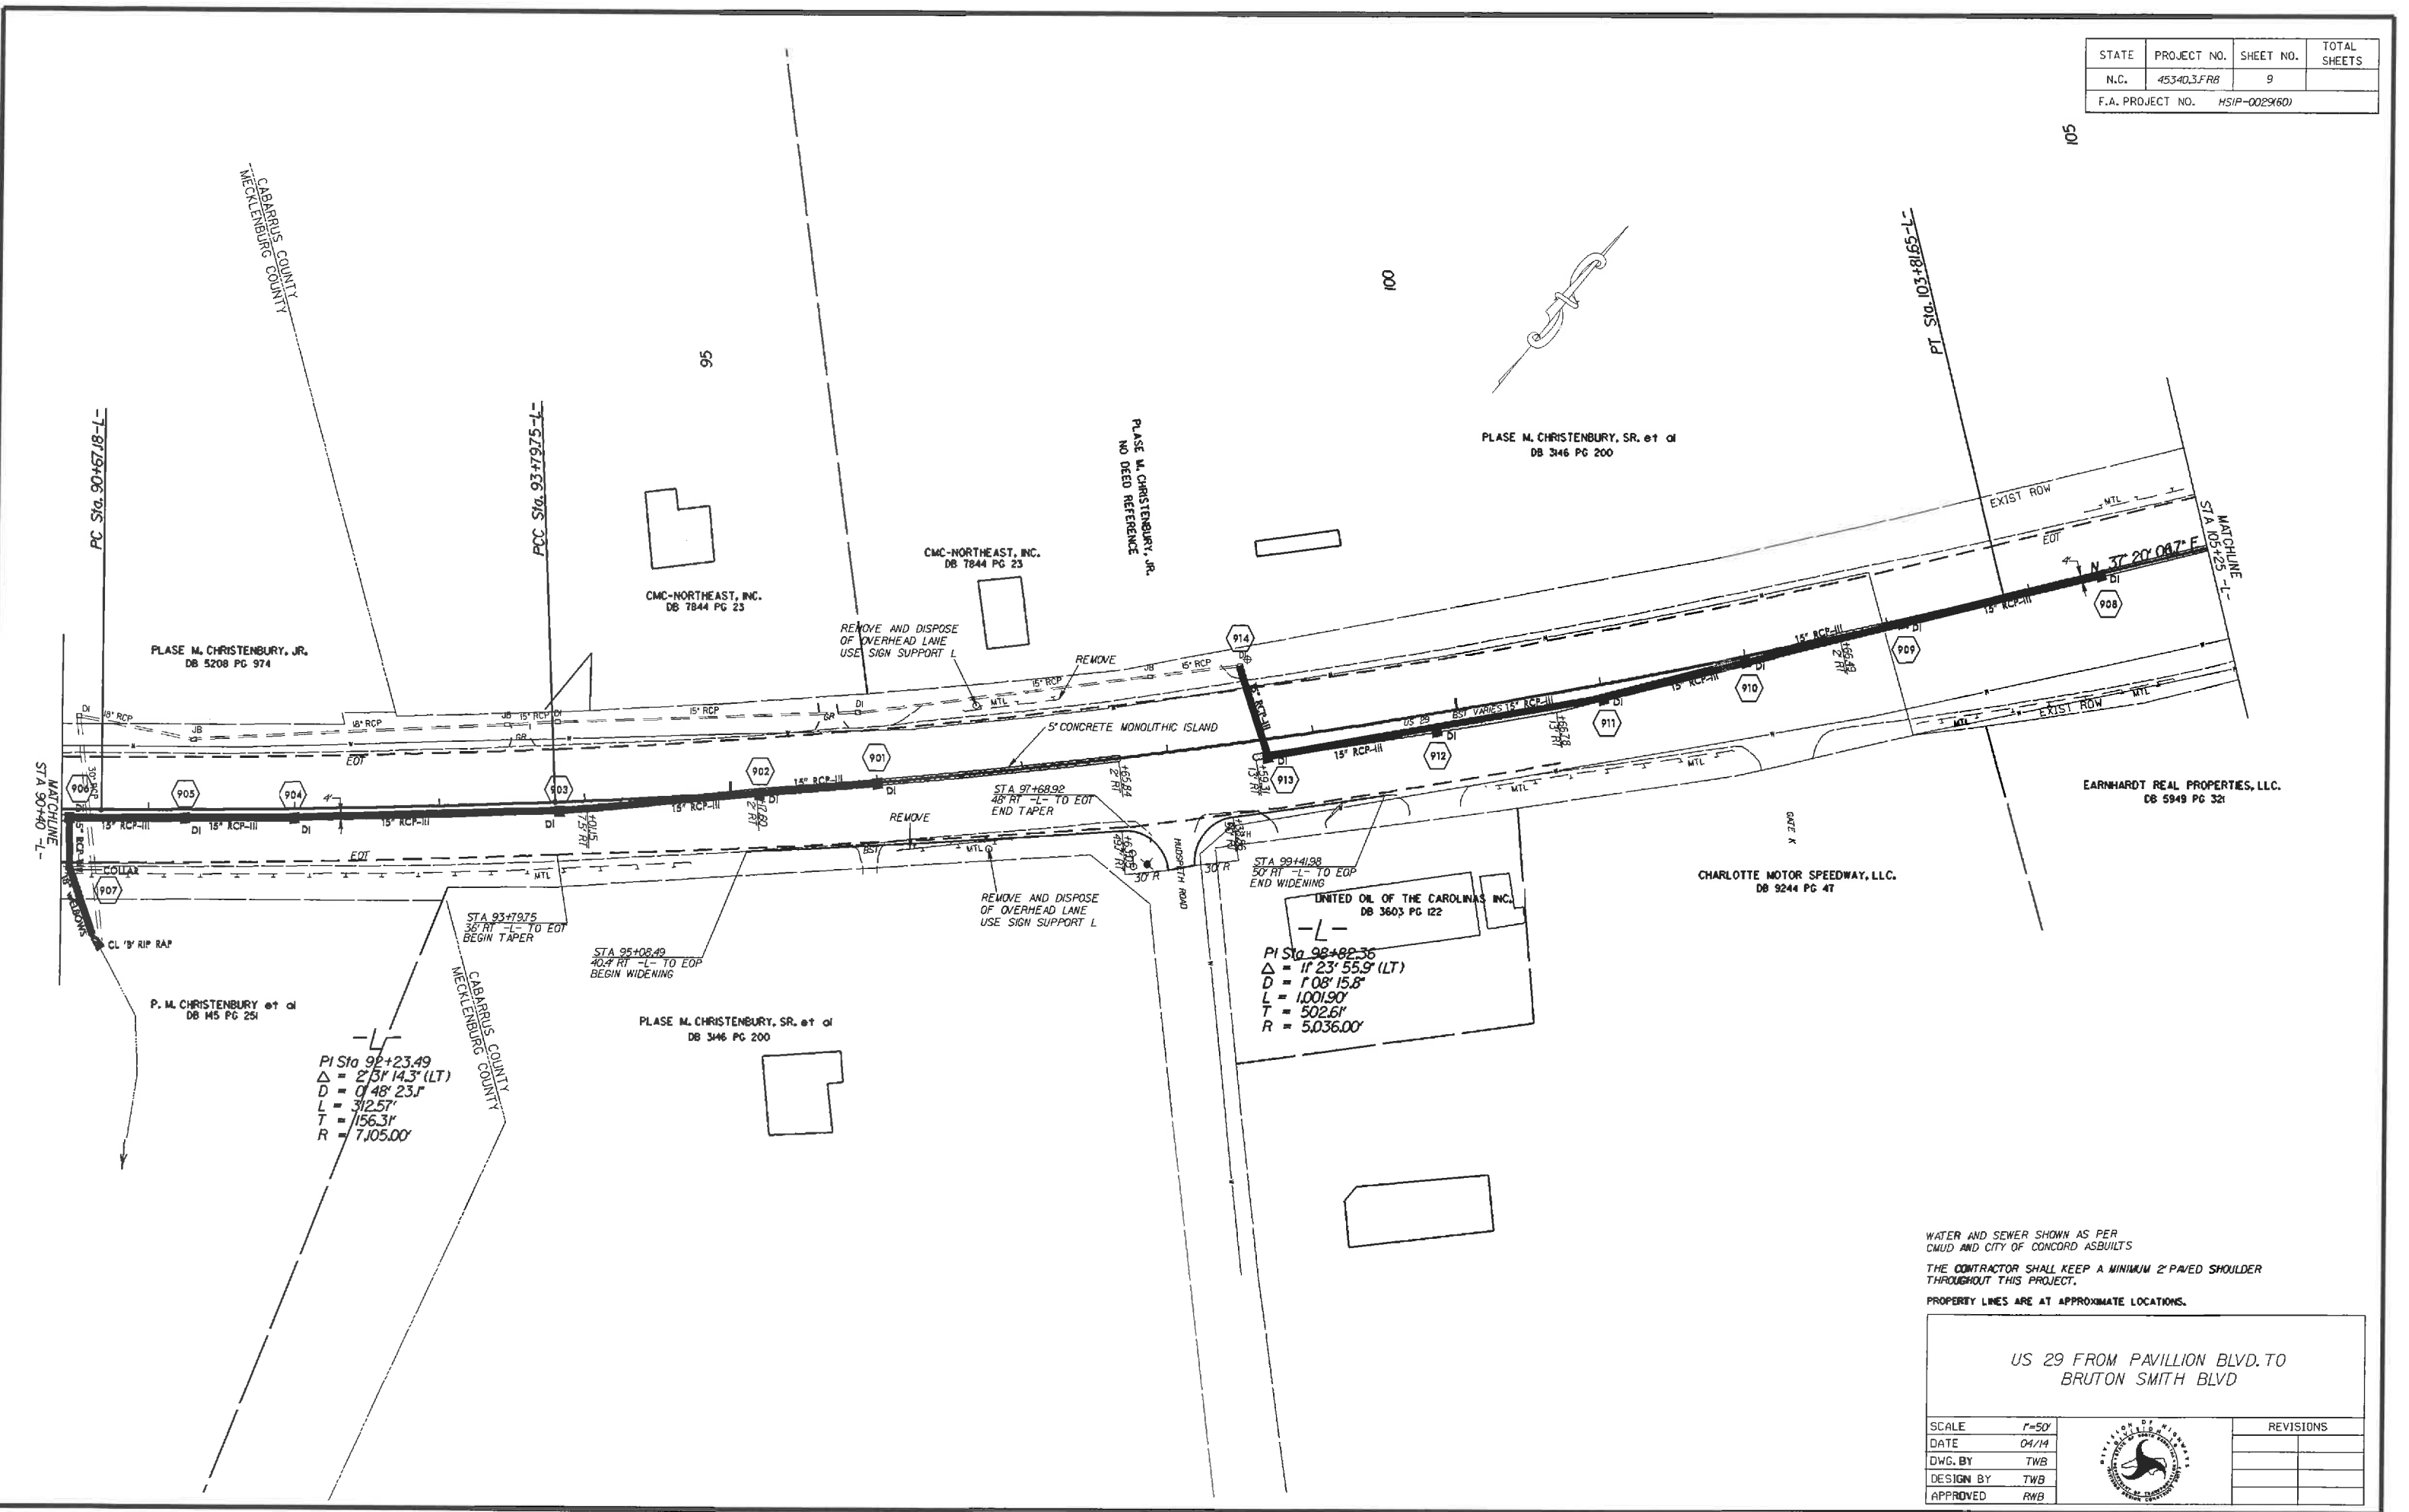


WATER AND SEWER SHOWN AS PER
 CMUD AND CITY OF CONCORD ASBUILTS
 THE CONTRACTOR SHALL KEEP A MINIMUM 2' PAVED SHOULDER
 THROUGHOUT THIS PROJECT.
 PROPERTY LINES ARE AT APPROXIMATE LOCATIONS.

US 29 FROM PAVILLION BLVD. TO
 BRUTON SMITH BLVD

SCALE	1"=50'		REVISIONS
DATE	04/14		
DWG. BY	TWB		
DESIGN BY	TWB		
APPROVED	RWB		

STATE	PROJECT NO.	SHEET NO.	TOTAL SHEETS
N.C.	45340.3FR8	10	
F.A. PROJECT NO. HSIP-002960			

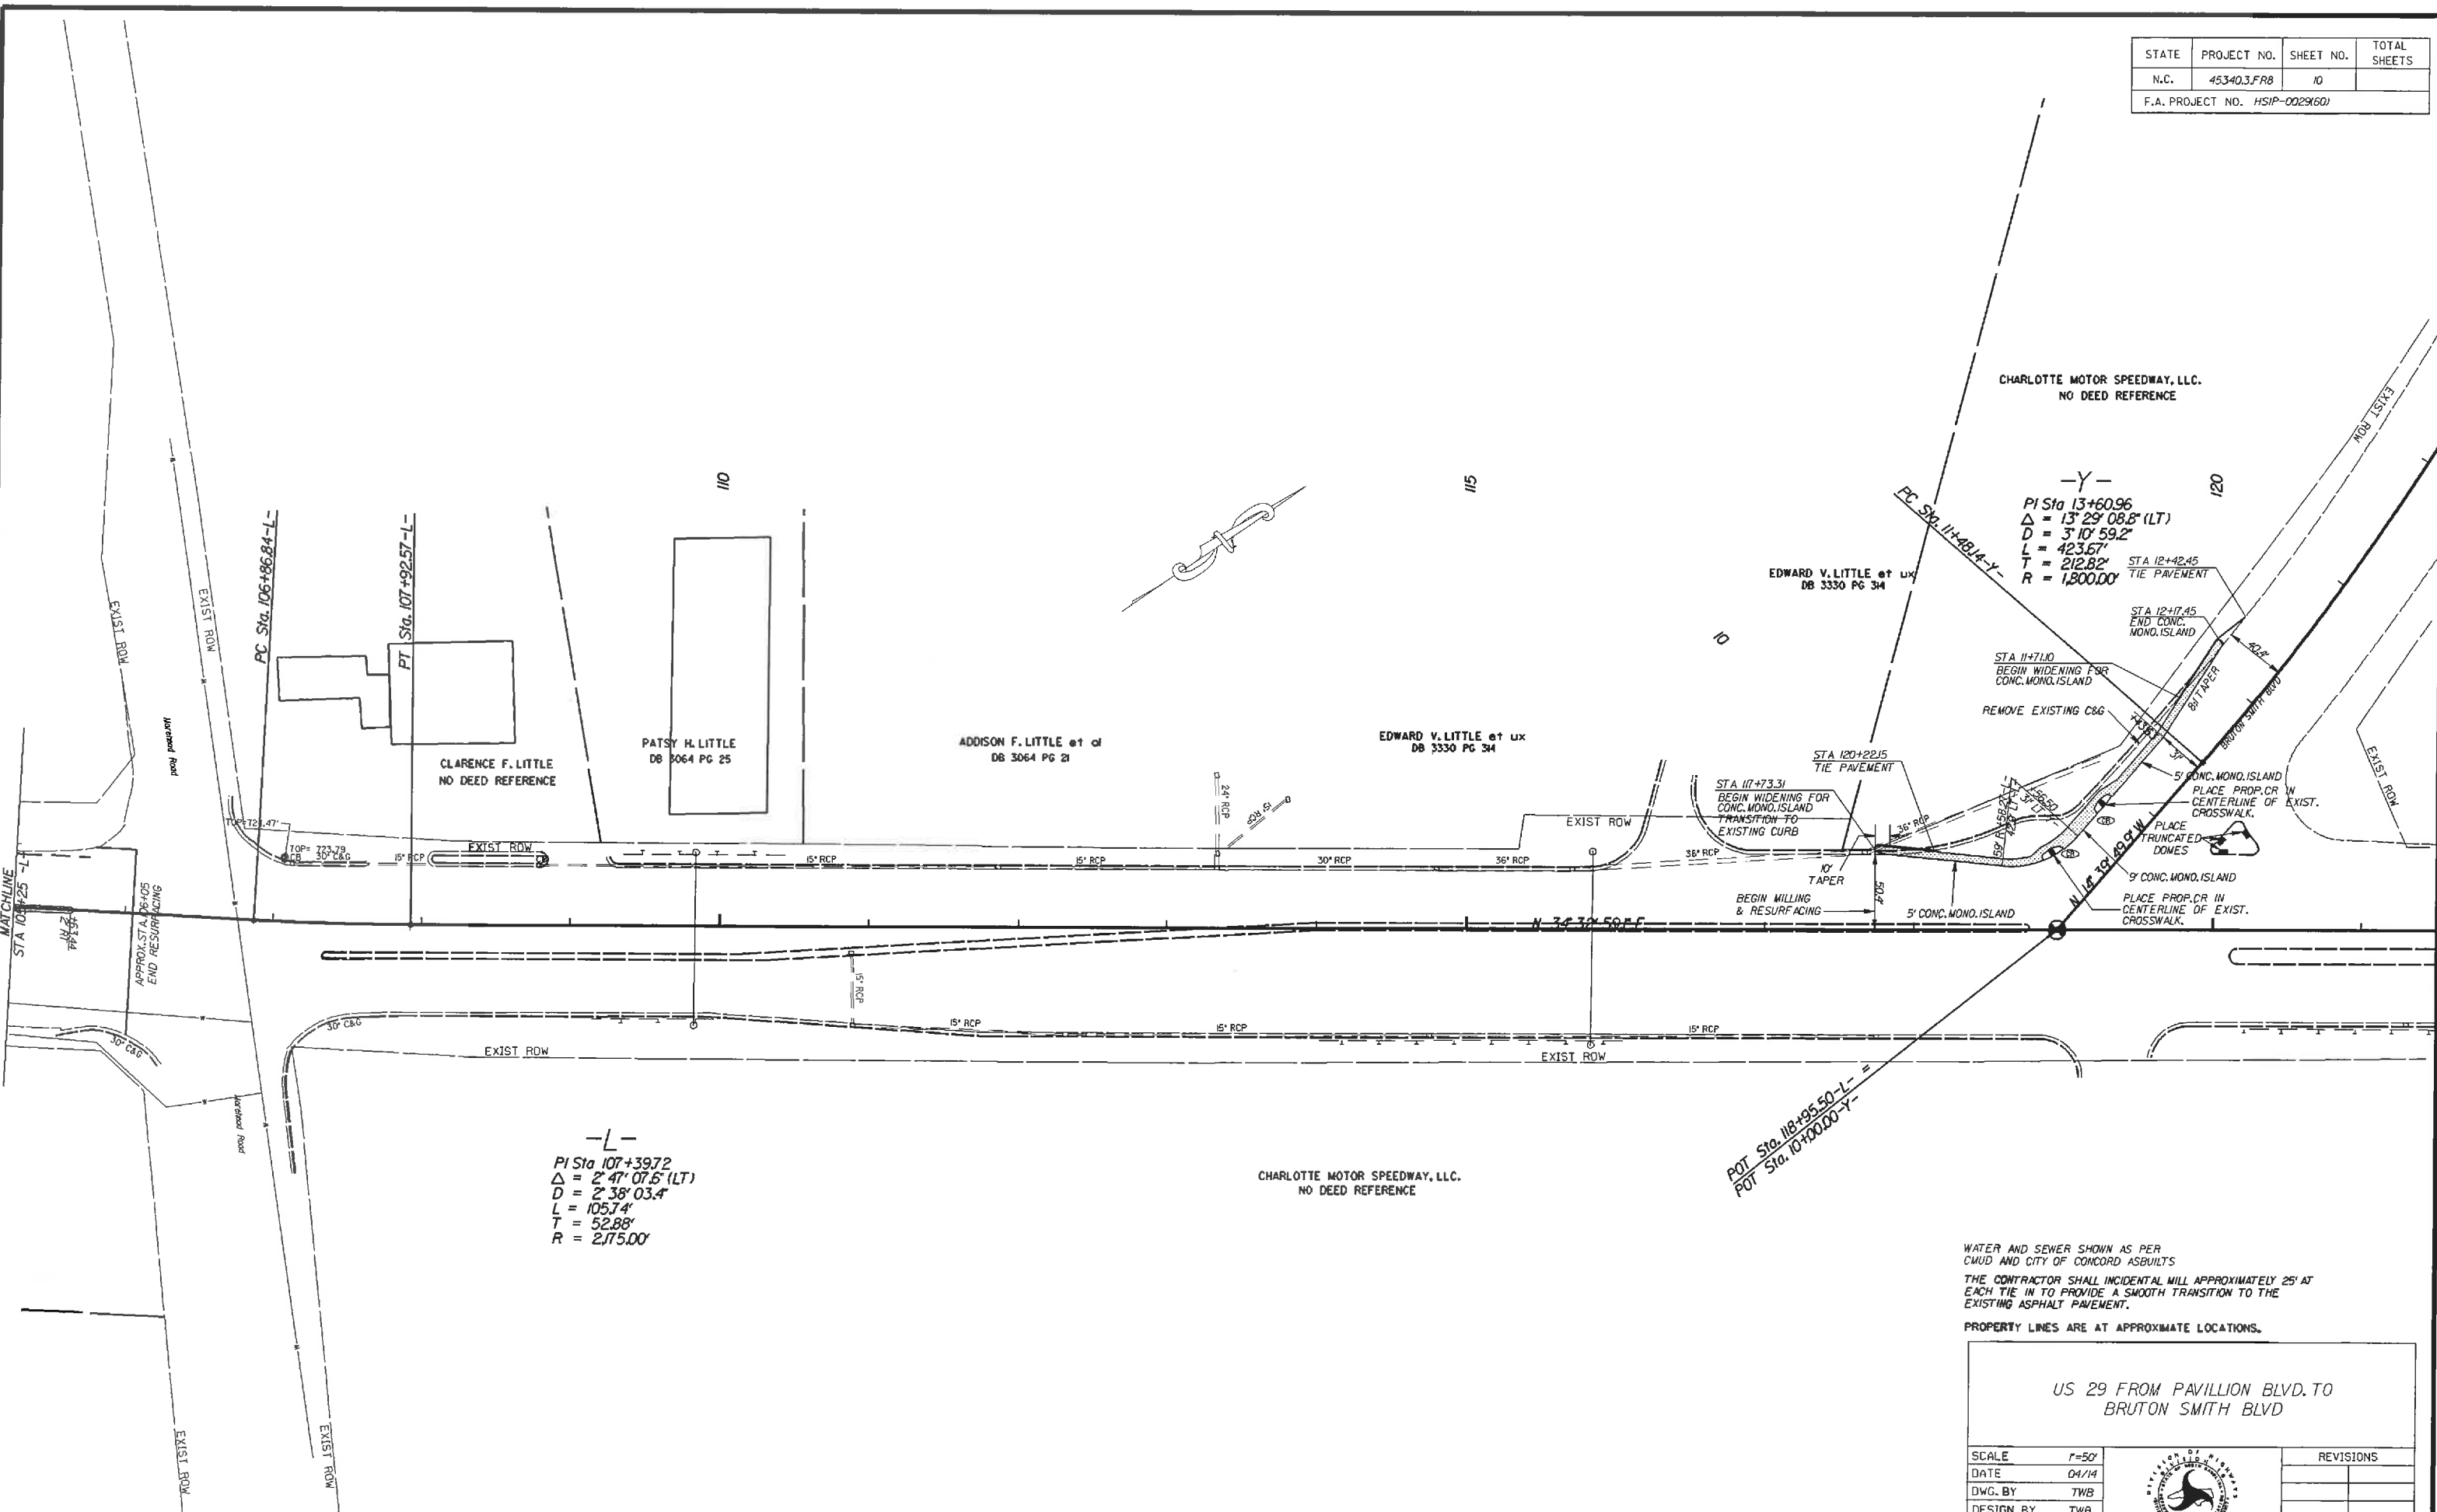

CHARLOTTE MOTOR SPEEDWAY, LLC.
NO DEED REFERENCE

-Y-
PI Sta 13+60.96
Δ = 13° 29' 08.6" (LT)
D = 3' 10' 59.2"
L = 423.67'
T = 212.82'
R = 1,800.00'

CLARENCE F. LITTLE
NO DEED REFERENCE

PATSY H. LITTLE
DB 8064 PG 25

ADDISON F. LITTLE et al
DB 3064 PG 21

EDWARD V. LITTLE et ux
DB 3330 PG 34

CHARLOTTE MOTOR SPEEDWAY, LLC.
NO DEED REFERENCE


-L-
PI Sta 107+39.72
Δ = 2° 47' 07.6" (LT)
D = 2' 38' 03.4"
L = 105.74'
T = 52.88'
R = 2,175.00'

WATER AND SEWER SHOWN AS PER
CMUD AND CITY OF CONCORD ASUILTS
THE CONTRACTOR SHALL INCIDENTAL MILL APPROXIMATELY 25' AT
EACH TIE IN TO PROVIDE A SMOOTH TRANSITION TO THE
EXISTING ASPHALT PAVEMENT.

PROPERTY LINES ARE AT APPROXIMATE LOCATIONS.

US 29 FROM PAVILLION BLVD. TO BRUTON SMITH BLVD		REVISIONS	
SCALE	1"=50'		
DATE	04/14		
DWG. BY	TWB		
DESIGN BY	TWB		
APPROVED	RWB		

STATE	PROJECT NO.	SHEET NO.	TOTAL SHEETS
N.C.	45340.3.FRB	II	
F.A. PROJECT NO.			

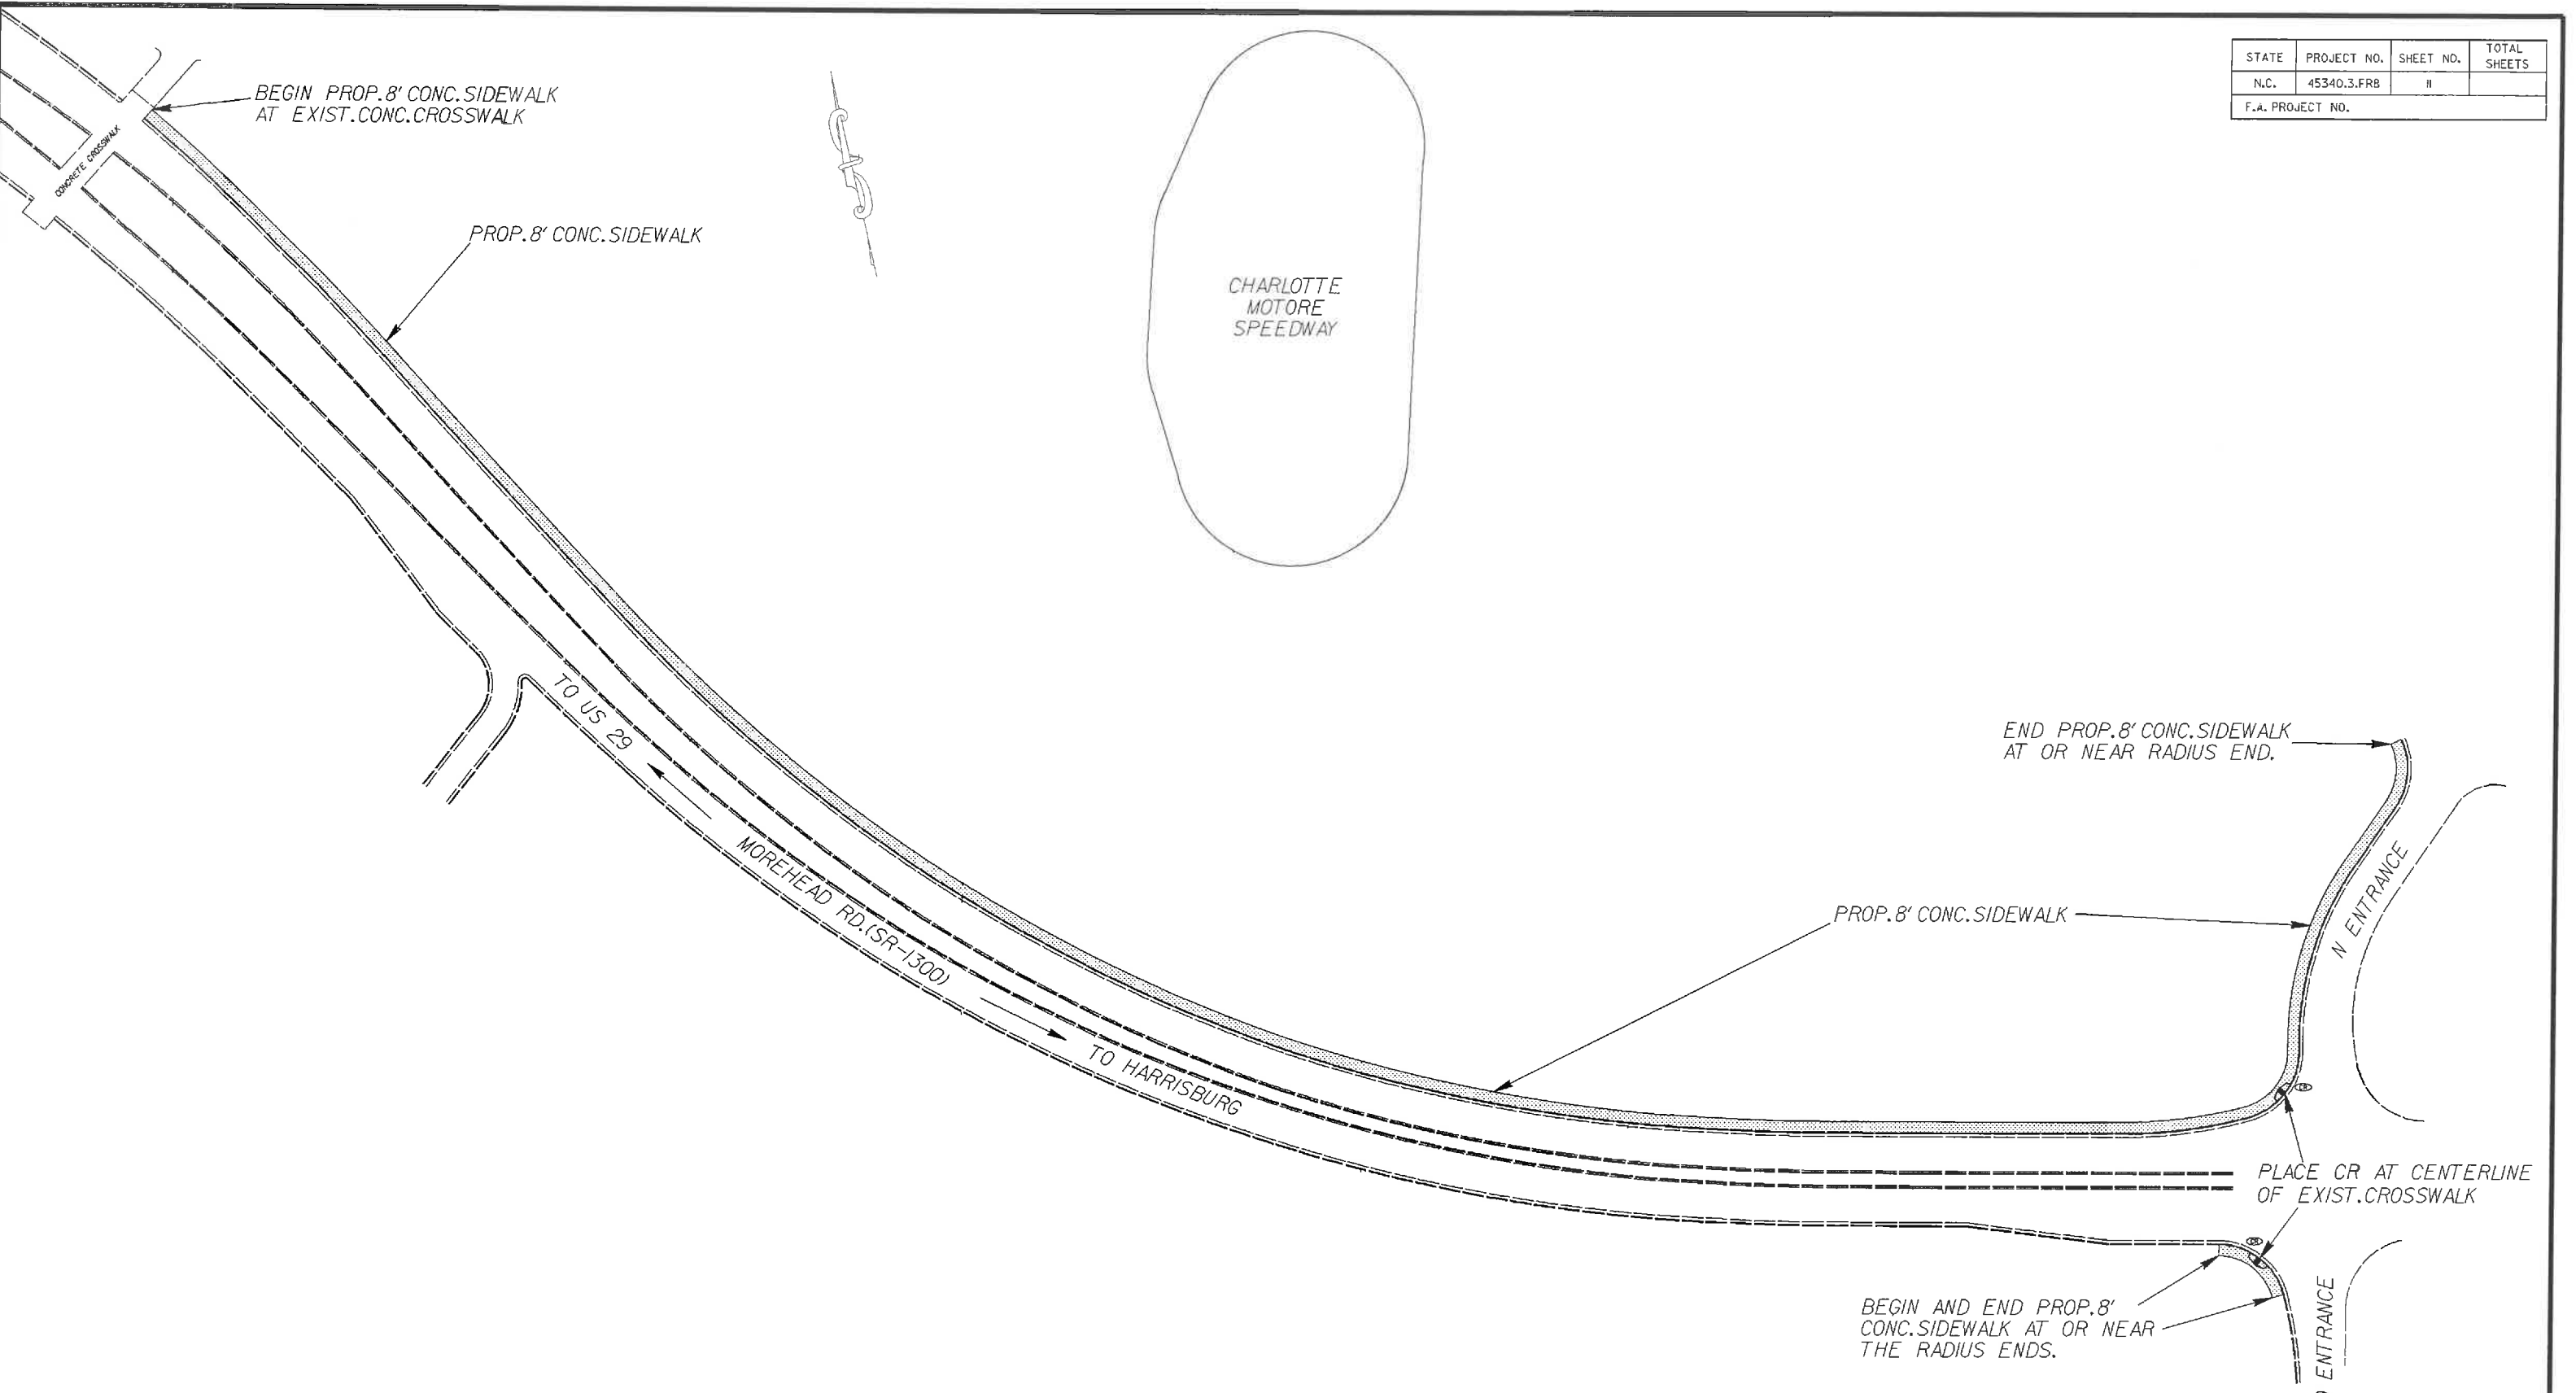

US 29 FROM PAVILION BLVD. TO
BRUTON SMITH BLVD.

SCALE	N/A		REVISIONS
DATE	7/14		
DWG. BY	TWB		
DESIGN BY	TWB		
APPROVED	RWB		

STATE	PROJECT NO.	SHEET NO.	TOTAL SHEETS
N.C.	45340.3FR8	PMP-1	
F.A. PROJECT NO. HSIP-0025601			


PAVEMENT MARKING SCHEDULE

PAVEMENT MARKING LINES

- | | |
|--|---|
| TA - WHITE EDGELINE (4', 90 MIL) | TU - WHITE DIAGONAL (12', 90 MIL) |
| TB - YELLOW EDGELINE (4', 90 MIL) | TV - YELLOW DIAGONAL (12', 90 MIL) |
| TC - 10FT. WHITE SKIP (4', 120 MIL) | T1 - WHITE LINE, RR X (16', 120 MIL) |
| TD - 3FT.-9FT./SP WHITE MINISKIP (4', 120 MIL) | T2 - WHITE STOPBAR (24', 120 MIL) |
| TE - WHITE SOLID LANE LINE (4', 120 MIL) | T3 - WHITE CROSSWALK LINE (24', 120 MIL) |
| TF - 10FT. YELLOW SKIP (4', 120 MIL) | T4 - WHITE RUMBLE STRIP (4", 240 MIL) |
| TH - YELLOW SINGLE CENTER (4', 120 MIL) | T5 - YELLOW RUMBLE STRIP (4", 240 MIL) |
| TI - YELLOW DOUBLE CENTER (4', 120 MIL) | T6 - WHITE EDGELINE (6', 90 MIL) |
| TJ - 10FT. WHITE SKIP (6', 120 MIL) | T7 - YELLOW EDGELINE (6', 90 MIL) |
| TK - 3FT.-9FT./SP WHITE MINISKIP (6', 120 MIL) | T8 - 2FT.-6FT./SP WHITE MINISKIP (4', 120 MIL) |
| TL - WHITE SOLID LANE LINE (6', 120 MIL) | T9 - 2FT.-6FT./SP YELLOW MINISKIP (4', 120 MIL) |
| TM - 10FT. YELLOW SKIP (6', 120 MIL) | T10 - 3FT.-3FT./SP WHITE MINISKIP (12', 120 MIL) |
| TN - WHITE GORELINE (8', 90 MIL) | T11 - 2FT.-6FT./SP WHITE MINISKIP (6', 120 MIL) |
| TO - WHITE DIAGONAL (8', 90 MIL) | T12 - 2FT.-6FT./SP YELLOW MINISKIP (6', 120 MIL) |
| TP - YELLOW DIAGONAL (8', 90 MIL) | T13 - 3FT.-9FT./SP WHITE MINISKIP (8', 120 MIL) |
| TQ - WHITE CROSSWALK LINE (8', 120 MIL) | T14 - 3FT.-9FT./SP WHITE MINISKIP (12', 120 MIL) |
| TR - WHITE SOLID LANE LINE (8', 120 MIL) | T15 - YELLOW SINGLE CENTER (6', 120 MIL) |
| TS - WHITE GORELINE (12', 90 MIL) | T16 - YELLOW DOUBLE CENTER (6', 120 MIL) |
| TT - WHITE SOLID LANE LINE (12', 120 MIL) | T17 - 3FT.-3FT./SP WHITE MINISKIP ENTRANCE LINE (8', 120 MIL) |

PAVEMENT MARKING SYMBOLS

- | | |
|--|--|
| UA - LEFT TURN ARROW (90 MIL) | UU - FISH-HOOK STRAIGHT ARROW (90 MIL) |
| UB - RIGHT TURN ARROW (90 MIL) | UV - FISH-HOOK LEFT/STRAIGHT ARROW (90 MIL) |
| UC - STRAIGHT ARROW (90 MIL) | UW - FISH-HOOK RIGHT/STRAIGHT ARROW (90 MIL) |
| UD - COMBO. LEFT/STRAIGHT ARROW (90 MIL) | UX - FISH-HOOK LEFT/RIGHT ARROW (90 MIL) |
| UE - COMBO. RIGHT/STRAIGHT ARROW (90 MIL) | UY - FISH-HOOK LEFT/RIGHT/STRAIGHT ARROW (90 MIL) |
| UF - COMBO. LEFT/RIGHT ARROW (90 MIL) | UZ - FISH-HOOK W/CIRCLE STRAIGHT ARROW (90 MIL) |
| UG - COMBO. LEFT/RIGHT/STRAIGHT ARROW (90 MIL) | WA - FISH-HOOK W/CIRCLE LEFT ARROW (90 MIL) |
| UH - HANDICAP PARKING (90 MIL) | WB - FISH-HOOK W/CIRCLE LEFT/STRAIGHT ARROW (90 MIL) |
| UI - ALPHANUMERIC CHAR. (120 MIL) | WC - FISH-HOOK W/CIRCLE LEFT/RIGHT/STRAIGHT ARROW (90 MIL) |
| UJ - BICYCLE SYMBOL (90 MIL) | MA - PERMANENT RAISED MARKER (YELLOW & YELLOW) |
| UK - BICYCLE STRAIGHT ARROW (90 MIL) | MB - PERMANENT RAISED MARKER (CRYSTAL & RED) |
| UL - BICYCLE CHAR. (120 MIL) | MC - PERMANENT RAISED MARKER (YELLOW & RED) |
| UM - 12" YIELD LINE TRIANGLE (90 MIL) | MD - PERMANENT RAISED MARKER (YELLOW) |
| UN - 24" YIELD LINE TRIANGLE (90 MIL) | ME - SNOWFLOWABLE MARKER (YELLOW & YELLOW) |
| UO - BICYCLE LEFT ARROW (90 MIL) | MF - SNOWFLOWABLE MARKER (CRYSTAL & RED) |
| UP - MERGE ARROW (90 MIL) | MG - SNOWFLOWABLE MARKER (YELLOW & RED) |
| UQ - RAMP ARROW SYMBOL (90 MIL) | ML - PERMANENT RAISED MARKER (CRYSTAL & CRYSTAL) |
| UR - SHARROW (90 MIL) | MO - SNOWFLOWABLE MARKER (CRYSTAL & CRYSTAL) |
| US - BICYCLE LOOP DETECTOR (90 MIL) | |
| UT - U-TURN ARROW (90 MIL) | |

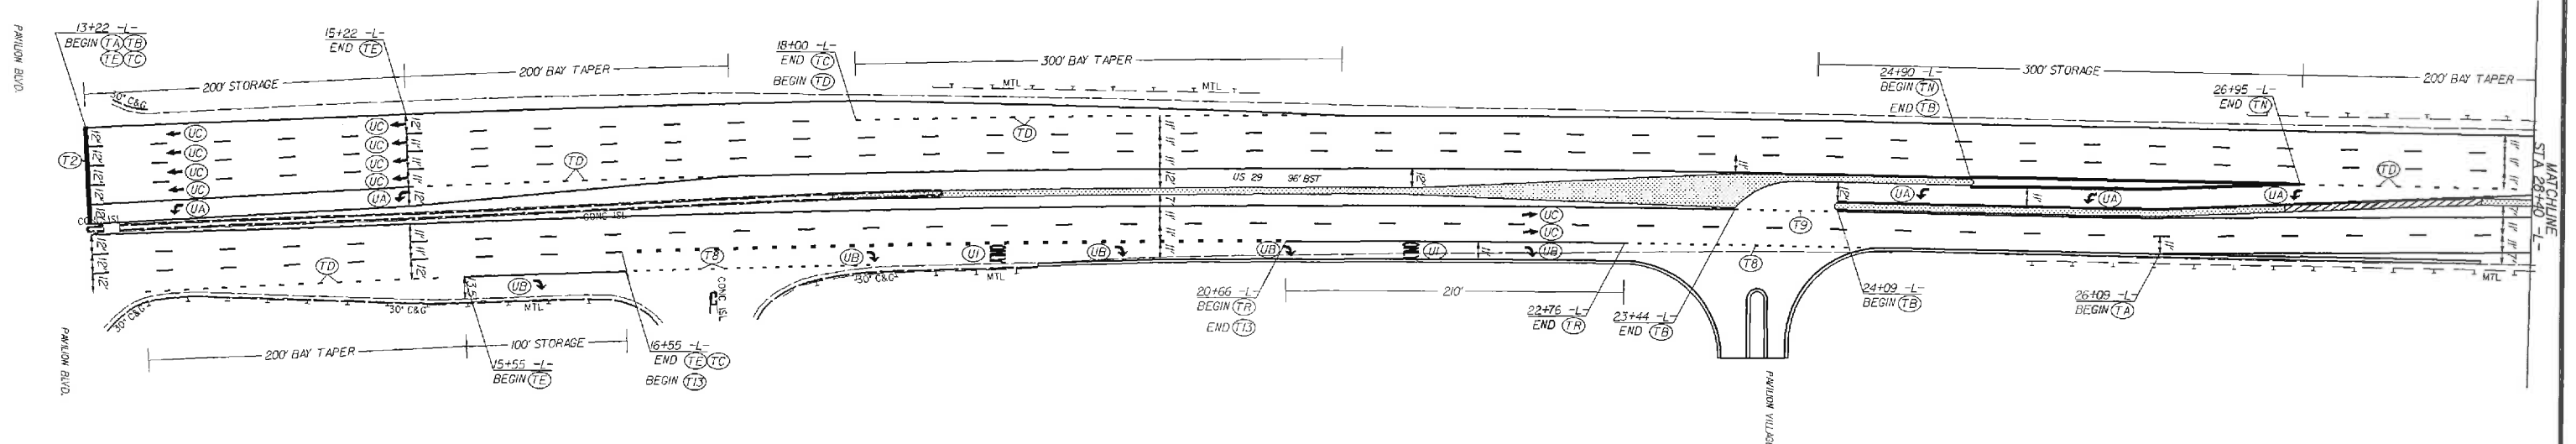

US 29 FROM PAVILLION BLVD. TO BRUTON SMITH BLVD.

SCALE	1"=50'		REVISIONS
DATE	04/14		
DWG. BY	TWB		
DESIGN BY	TWB		
APPROVED	RWB		

PAVEMENT MARKING SCHEDULE


STATE	PROJECT NO.	SHEET NO.	TOTAL SHEETS
N.C.	45340.3FR8	PMP-2	
F.A. PROJECT NO. HSIP-0029(60)			

PAVEMENT MARKING LINES

- TA - WHITE EDGELINE (4', 90 MIL)
- TB - YELLOW EDGELINE (4', 90 MIL)
- TC - 10FT. WHITE SKIP (4', 120 MIL)
- TD - 3FT.-9FT./SP WHITE MINISKIP (4', 120 MIL)
- TE - WHITE SOLID LANE LINE (4', 120 MIL)
- TF - 10FT. YELLOW SKIP (4', 120 MIL)
- TH - YELLOW SINGLE CENTER (4', 120 MIL)
- TI - YELLOW DOUBLE CENTER (4', 120 MIL)
- TJ - 10FT. WHITE SKIP (6', 120 MIL)
- TK - 3FT.-9FT./SP WHITE MINISKIP (6', 120 MIL)
- TL - WHITE SOLID LANE LINE (6', 120 MIL)
- TM - 10FT. YELLOW SKIP (6', 120 MIL)
- TN - WHITE GORELINE (8', 90 MIL)
- TO - WHITE DIAGONAL (8', 90 MIL)
- TP - YELLOW DIAGONAL (8', 90 MIL)
- TQ - WHITE CROSSWALK LINE (8', 120 MIL)
- TR - WHITE SOLID LANE LINE (8', 120 MIL)
- TS - WHITE GORELINE (12', 90 MIL)
- TT - WHITE SOLID LANE LINE (12', 120 MIL)
- TU - WHITE DIAGONAL (12', 90 MIL)
- TV - YELLOW DIAGONAL (12', 90 MIL)
- T1 - WHITE LINE, RR X (16', 120 MIL)
- T2 - WHITE STOPBAR (24', 120 MIL)
- T3 - WHITE CROSSWALK LINE (24', 120 MIL)
- T4 - WHITE RUMBLE STRIP (4', 240 MIL)
- T5 - YELLOW RUMBLE STRIP (4', 240 MIL)
- T6 - WHITE EDGELINE (6', 90 MIL)
- T7 - YELLOW EDGELINE (6', 90 MIL)
- T8 - 2FT.-6FT./SP WHITE MINISKIP (4', 120 MIL)
- T9 - 2FT.-6FT./SP YELLOW MINISKIP (4', 120 MIL)
- T10 - 3FT.-3FT./SP WHITE MINISKIP (12', 120 MIL)
- T11 - 2FT.-6FT./SP WHITE MINISKIP (6', 120 MIL)
- T12 - 2FT.-6FT./SP YELLOW MINISKIP (6', 120 MIL)
- T13 - 3FT.-9FT./SP WHITE MINISKIP (8', 120 MIL)
- T14 - 3FT.-9FT./SP WHITE MINISKIP (12', 120 MIL)
- T15 - YELLOW SINGLE CENTER (6', 120 MIL)
- T16 - YELLOW DOUBLE CENTER (6', 120 MIL)
- T17 - 3FT.-3FT./SP WHITE MINISKIP ENTRANCE LINE (8', 120 MIL)

PAVEMENT MARKING SYMBOLS

- UA - LEFT TURN ARROW (90 MIL)
- UB - RIGHT TURN ARROW (90 MIL)
- UC - STRAIGHT ARROW (90 MIL)
- UD - COMBO. LEFT/STRAIGHT ARROW (90 MIL)
- UE - COMBO. RIGHT/STRAIGHT ARROW (90 MIL)
- UF - COMBO. LEFT/RIGHT ARROW (90 MIL)
- UG - COMBO. LEFT/RIGHT/STRAIGHT ARROW (90 MIL)
- UH - HANDICAP PARKING (90 MIL)
- UI - ALPHANUMERIC CHAR. (120 MIL)
- UJ - BICYCLE SYMBOL (90 MIL)
- UK - BICYCLE STRAIGHT ARROW (90 MIL)
- UL - BICYCLE CHAR. (120 MIL)
- UM - 12" YIELD LINE TRIANGLE (90 MIL)
- UN - 24" YIELD LINE TRIANGLE (90 MIL)
- UO - BICYCLE LEFT ARROW (90 MIL)
- UP - MERGE ARROW (90 MIL)
- UQ - RAMP ARROW SYMBOL (90 MIL)
- UR - SHARROW (90 MIL)
- US - BICYCLE LOOP DETECTOR (90 MIL)
- UT - U-TURN ARROW (90 MIL)
- UU - FISH-HOOK STRAIGHT ARROW (90 MIL)
- UV - FISH-HOOK LEFT/STRAIGHT ARROW (90 MIL)
- UW - FISH-HOOK RIGHT/STRAIGHT ARROW (90 MIL)
- UX - FISH-HOOK LEFT/RIGHT ARROW (90 MIL)
- UY - FISH-HOOK LEFT/RIGHT/STRAIGHT ARROW (90 MIL)
- UZ - FISH-HOOK W/CIRCLE STRAIGHT ARROW (90 MIL)
- WA - FISH-HOOK W/CIRCLE LEFT ARROW (90 MIL)
- WB - FISH-HOOK W/CIRCLE LEFT/STRAIGHT ARROW (90 MIL)
- WC - FISH-HOOK W/CIRCLE LEFT/RIGHT/STRAIGHT ARROW (90 MIL)
- MA - PERMANENT RAISED MARKER (YELLOW & YELLOW)
- MB - PERMANENT RAISED MARKER (CRYSTAL & RED)
- MC - PERMANENT RAISED MARKER (YELLOW & RED)
- MD - PERMANENT RAISED MARKER (YELLOW)
- ME - SNOWPLOWABLE MARKER (YELLOW & YELLOW)
- MF - SNOWPLOWABLE MARKER (CRYSTAL & RED)
- MG - SNOWPLOWABLE MARKER (YELLOW & RED)
- ML - PERMANENT RAISED MARKER (CRYSTAL & CRYSTAL)
- MO - SNOWPLOWABLE MARKER (CRYSTAL & CRYSTAL)

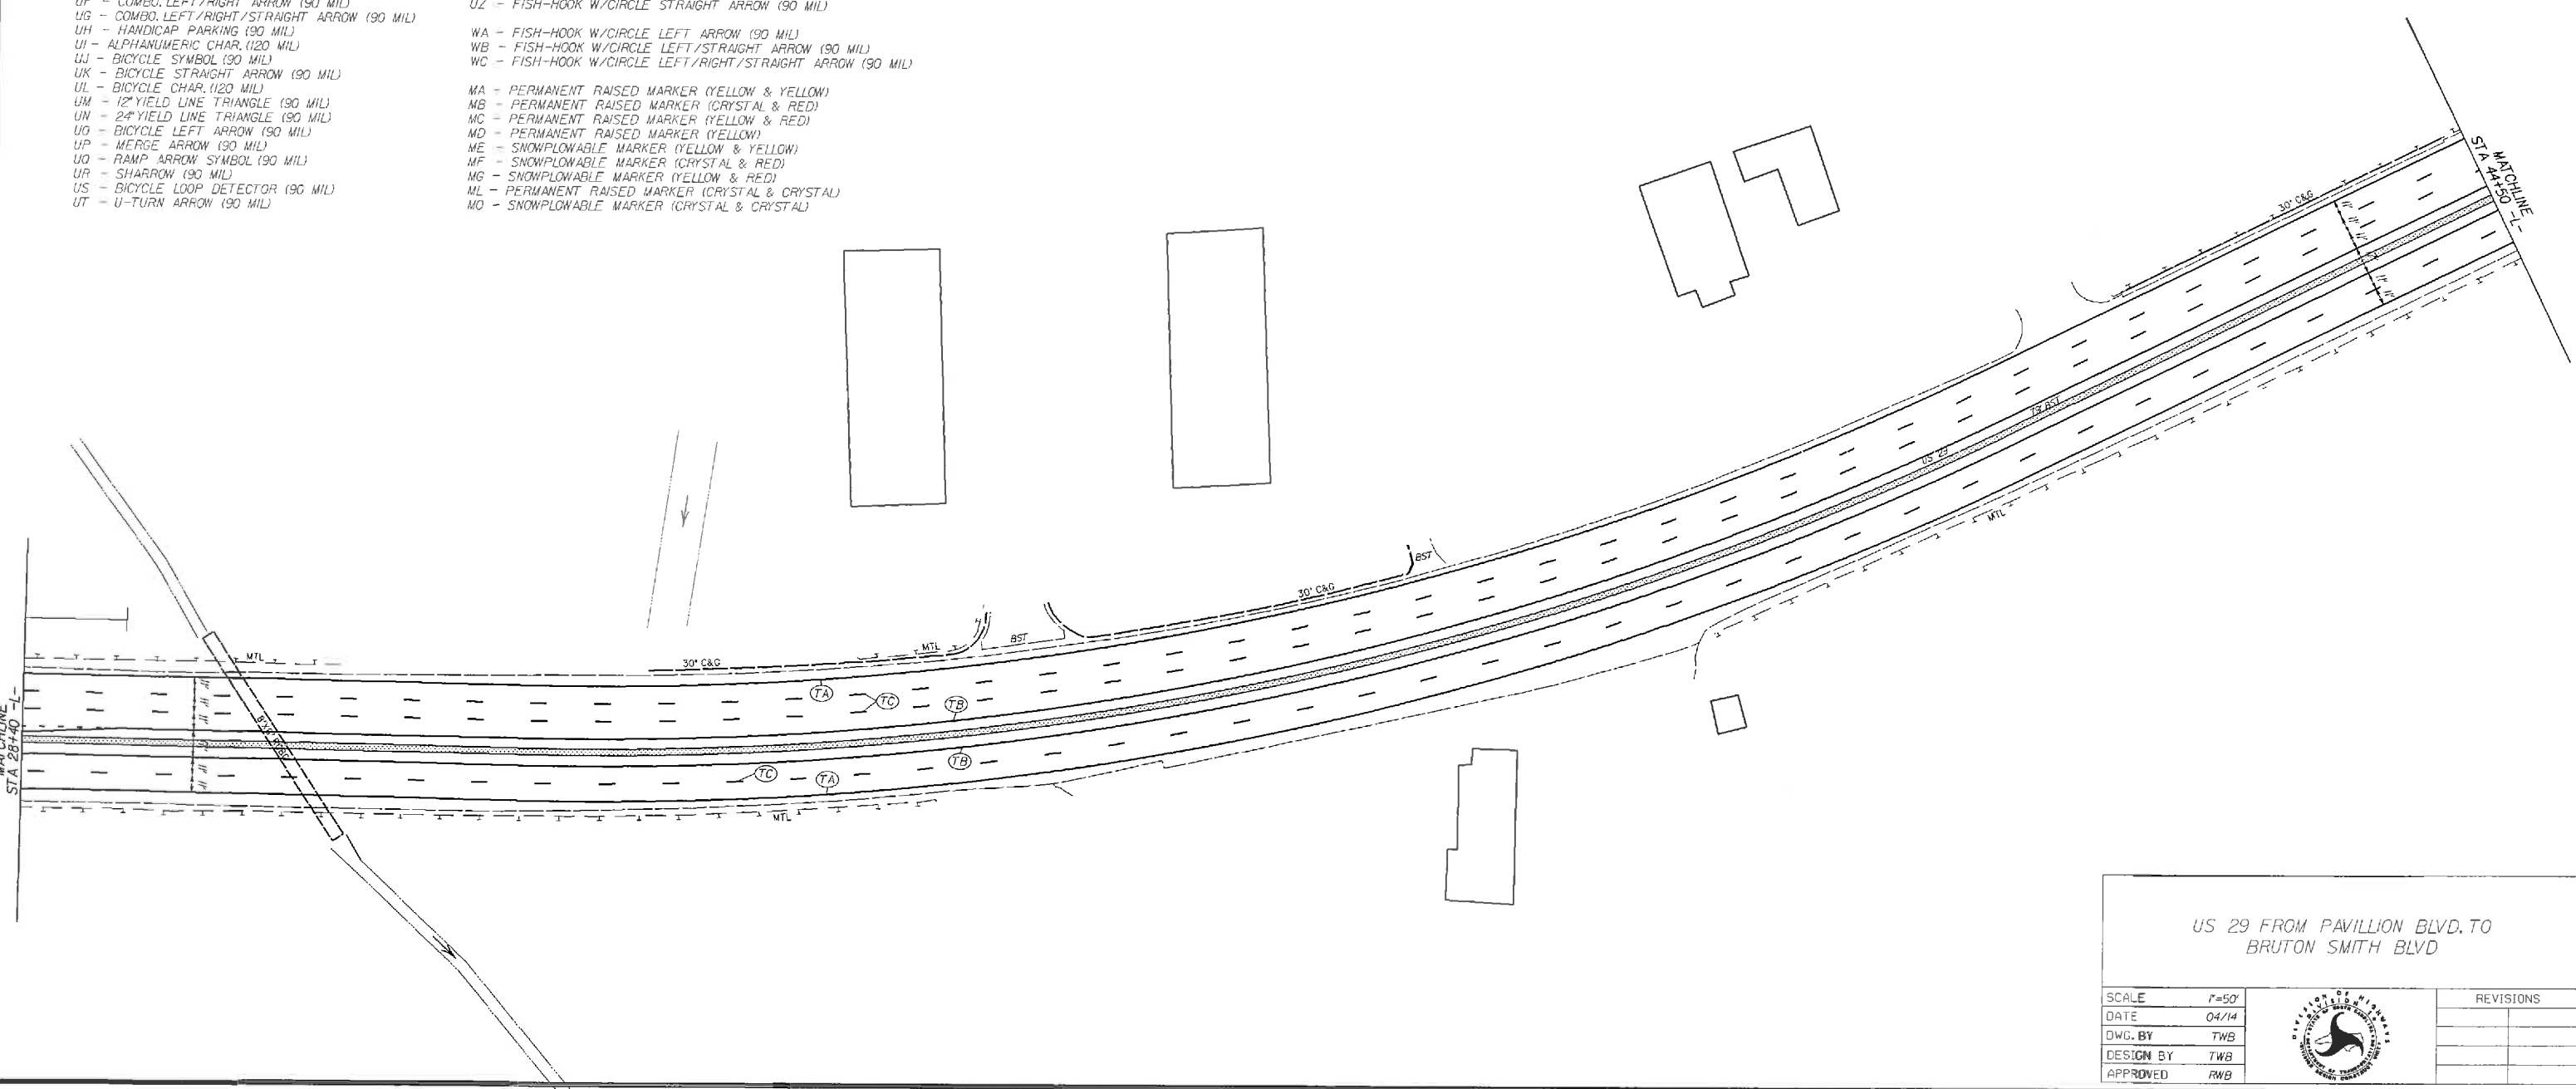

US 29 FROM PAVILLION BLVD. TO BRUTON SMITH BLVD

SCALE	1"=50'		REVISIONS
DATE	04/14		
DWG. BY	TWB		
DESIGN BY	TWB		
APPROVED	RWB		

STATE	PROJECT NO.	SHEET NO.	TOTAL SHEETS
N.C.	45340.3.FR8	PMP-3	
F.A. PROJECT NO.		HSIP-0029(60)	


PAVEMENT MARKING SCHEDULE

PAVEMENT MARKING LINES

- | | |
|--|---|
| TA - WHITE EDGELINE (4', 90 MIL) | TU - WHITE DIAGONAL (12', 90 MIL) |
| TB - YELLOW EDGELINE (4', 90 MIL) | TV - YELLOW DIAGONAL (12', 90 MIL) |
| TC - 10FT. WHITE SKIP (4', 120 MIL) | T1 - WHITE LINE, RR X (16', 120 MIL) |
| TD - 3FT.-9FT./SP WHITE MINISKIP (4', 120 MIL) | T2 - WHITE STOPBAR (24', 120 MIL) |
| TE - WHITE SOLID LANE LINE (4', 120 MIL) | T3 - WHITE CROSSWALK LINE (24', 120 MIL) |
| TF - 10FT. YELLOW SKIP (4', 120 MIL) | T4 - WHITE RUMBLE STRIP (4', 240 MIL) |
| TH - YELLOW SINGLE CENTER (4', 120 MIL) | T5 - YELLOW RUMBLE STRIP (4', 240 MIL) |
| TI - YELLOW DOUBLE CENTER (4', 120 MIL) | T6 - WHITE EDGELINE (6', 90 MIL) |
| TJ - 10FT. WHITE SKIP (6', 120 MIL) | T7 - YELLOW EDGELINE (6', 90 MIL) |
| TK - 3FT.-9FT./SP WHITE MINISKIP (6', 120 MIL) | T8 - 2FT.-6FT./SP WHITE MINISKIP (4', 120 MIL) |
| TL - WHITE SOLID LANE LINE (6', 120 MIL) | T9 - 2FT.-6FT./SP YELLOW MINISKIP (4', 120 MIL) |
| TM - 10FT. YELLOW SKIP (6', 120 MIL) | T10 - 3FT.-3FT./SP WHITE MINISKIP (12', 120 MIL) |
| TN - WHITE GORELINE (8', 90 MIL) | T11 - 2FT.-6FT./SP WHITE MINISKIP (6', 120 MIL) |
| TO - WHITE DIAGONAL (8', 90 MIL) | T12 - 2FT.-6FT./SP YELLOW MINISKIP (6', 120 MIL) |
| TP - YELLOW DIAGONAL (8', 90 MIL) | T13 - 3FT.-9FT./SP WHITE MINISKIP (8', 120 MIL) |
| TQ - WHITE CROSSWALK LINE (8', 120 MIL) | T14 - 3FT.-9FT./SP WHITE MINISKIP (12', 120 MIL) |
| TR - WHITE SOLID LANE LINE (8', 120 MIL) | T15 - YELLOW SINGLE CENTER (6', 120 MIL) |
| TS - WHITE GORELINE (12', 90 MIL) | T16 - YELLOW DOUBLE CENTER (6', 120 MIL) |
| TT - WHITE SOLID LANE LINE (12', 120 MIL) | T17 - 3FT.-3FT./SP WHITE MINISKIP ENTRANCE LINE (8', 120 MIL) |

PAVEMENT MARKING SYMBOLS

- | | |
|--|--|
| UA - LEFT TURN ARROW (90 MIL) | UU - FISH-HOOK STRAIGHT ARROW (90 MIL) |
| UB - RIGHT TURN ARROW (90 MIL) | UV - FISH-HOOK LEFT/STRAIGHT ARROW (90 MIL) |
| UC - STRAIGHT ARROW (90 MIL) | UW - FISH-HOOK RIGHT/STRAIGHT ARROW (90 MIL) |
| UD - COMBO. LEFT/STRAIGHT ARROW (90 MIL) | UX - FISH-HOOK LEFT/RIGHT ARROW (90 MIL) |
| UE - COMBO. RIGHT/STRAIGHT ARROW (90 MIL) | UY - FISH-HOOK LEFT/RIGHT/STRAIGHT ARROW (90 MIL) |
| UF - COMBO. LEFT/RIGHT ARROW (90 MIL) | UZ - FISH-HOOK W/CIRCLE STRAIGHT ARROW (90 MIL) |
| UG - COMBO. LEFT/RIGHT/STRAIGHT ARROW (90 MIL) | |
| UH - HANDICAP PARKING (90 MIL) | WA - FISH-HOOK W/CIRCLE LEFT ARROW (90 MIL) |
| UI - ALPHANUMERIC CHAR. (120 MIL) | WB - FISH-HOOK W/CIRCLE LEFT/STRAIGHT ARROW (90 MIL) |
| UJ - BICYCLE SYMBOL (90 MIL) | WC - FISH-HOOK W/CIRCLE LEFT/RIGHT/STRAIGHT ARROW (90 MIL) |
| UK - BICYCLE STRAIGHT ARROW (90 MIL) | |
| UL - BICYCLE CHAR. (120 MIL) | MA - PERMANENT RAISED MARKER (YELLOW & YELLOW) |
| UM - 12" YIELD LINE TRIANGLE (90 MIL) | MB - PERMANENT RAISED MARKER (CRYSTAL & RED) |
| UN - 24" YIELD LINE TRIANGLE (90 MIL) | MC - PERMANENT RAISED MARKER (YELLOW & RED) |
| UO - BICYCLE LEFT ARROW (90 MIL) | MD - PERMANENT RAISED MARKER (YELLOW) |
| UP - MERGE ARROW (90 MIL) | ME - SNOWPLOWABLE MARKER (YELLOW & YELLOW) |
| UQ - RAMP ARROW SYMBOL (90 MIL) | MF - SNOWPLOWABLE MARKER (CRYSTAL & RED) |
| UR - SHARROW (90 MIL) | MG - SNOWPLOWABLE MARKER (YELLOW & RED) |
| US - BICYCLE LOOP DETECTOR (90 MIL) | ML - PERMANENT RAISED MARKER (CRYSTAL & CRYSTAL) |
| UT - U-TURN ARROW (90 MIL) | MO - SNOWPLOWABLE MARKER (CRYSTAL & CRYSTAL) |

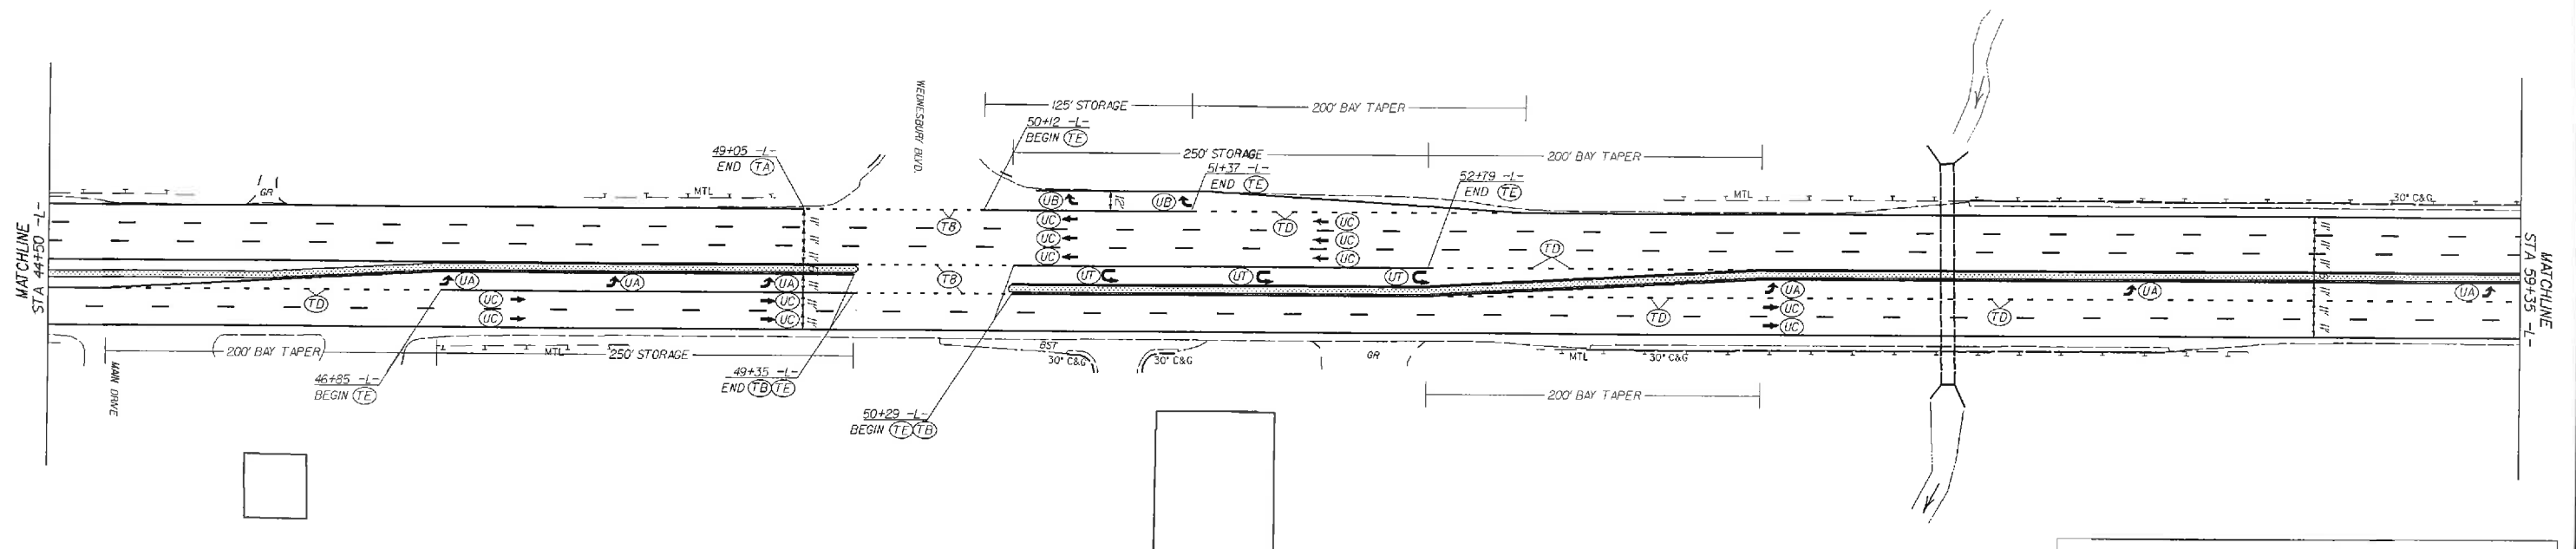

US 29 FROM PAVILLION BLVD. TO
BRUTON SMITH BLVD

SCALE	1"=50'		REVISIONS
DATE	04/14		
DESIGN BY	TWB		
APPROVED	RWB		

STATE	PROJECT NO.	SHEET NO.	TOTAL SHEETS
N.C.	45340.3FR8	PMP-4	
F.A. PROJECT NO. HSIP-0029601			


PAVEMENT MARKING SCHEDULE

PAVEMENT MARKING LINES

- | | |
|--|---|
| TA - WHITE EDGELINE (4',.90 MIL) | TU - WHITE DIAGONAL (12',.90 MIL) |
| TB - YELLOW EDGELINE (4',.90 MIL) | TV - YELLOW DIAGONAL (12',.90 MIL) |
| TC - 10FT. WHITE SKIP (4',.120 MIL) | T1 - WHITE LINE, RR X (16',.120 MIL) |
| TD - 3FT.-9FT./SP WHITE MINISKIP (4',.120 MIL) | T2 - WHITE STOPBAR (24',.120 MIL) |
| TE - WHITE SOLID LANE LINE (4',.120 MIL) | T3 - WHITE CROSSWALK LINE (24',.120 MIL) |
| TF - 10FT. YELLOW SKIP (4',.120 MIL) | T4 - WHITE RUMBLE STRIP (4',.240 MIL) |
| TH - YELLOW SINGLE CENTER (4',.120 MIL) | T5 - YELLOW RUMBLE STRIP (4',.240 MIL) |
| TI - YELLOW DOUBLE CENTER (4',.120 MIL) | T6 - WHITE EDGELINE (6',.90 MIL) |
| TJ - 10FT. WHITE SKIP (6',.120 MIL) | T7 - YELLOW EDGELINE (6',.90 MIL) |
| TK - 3FT.-9FT./SP WHITE MINISKIP (6',.120 MIL) | T8 - 2FT.-6FT./SP WHITE MINISKIP (4',.120 MIL) |
| TL - WHITE SOLID LANE LINE (6',.120 MIL) | T9 - 2FT.-6FT./SP YELLOW MINISKIP (4',.120 MIL) |
| TM - 10FT. YELLOW SKIP (6',.120 MIL) | T10 - 3FT.-3FT./SP WHITE MINISKIP (12',.120 MIL) |
| TN - WHITE GORELINE (8',.90 MIL) | T11 - 2FT.-6FT./SP WHITE MINISKIP (6',.120 MIL) |
| TO - WHITE DIAGONAL (8',.90 MIL) | T12 - 2FT.-6FT./SP YELLOW MINISKIP (6',.120 MIL) |
| TP - YELLOW DIAGONAL (8',.90 MIL) | T13 - 3FT.-9FT./SP WHITE MINISKIP (8',.120 MIL) |
| TQ - WHITE CROSSWALK LINE (8',.120 MIL) | T14 - 3FT.-9FT./SP WHITE MINISKIP (12',.120 MIL) |
| TR - WHITE SOLID LANE LINE (8',.120 MIL) | T15 - YELLOW SINGLE CENTER (6',.120 MIL) |
| TS - WHITE GORELINE (12',.90 MIL) | T16 - YELLOW DOUBLE CENTER (6',.120 MIL) |
| TT - WHITE SOLID LANE LINE (12',.120 MIL) | T17 - 3FT.-3FT./SP WHITE MINISKIP ENTRANCE LINE (8',.120 MIL) |

PAVEMENT MARKING SYMBOLS

- | | |
|--|--|
| UA - LEFT TURN ARROW (90 MIL) | UU - FISH-HOOK STRAIGHT ARROW (90 MIL) |
| UB - RIGHT TURN ARROW (90 MIL) | UV - FISH-HOOK LEFT/STRAIGHT ARROW (90 MIL) |
| UC - STRAIGHT ARROW (90 MIL) | UW - FISH-HOOK RIGHT/STRAIGHT ARROW (90 MIL) |
| UD - COMBO. LEFT/STRAIGHT ARROW (90 MIL) | UX - FISH-HOOK LEFT/RIGHT ARROW (90 MIL) |
| UE - COMBO. RIGHT/STRAIGHT ARROW (90 MIL) | UY - FISH-HOOK LEFT/RIGHT/STRAIGHT ARROW (90 MIL) |
| UF - COMBO. LEFT/RIGHT ARROW (90 MIL) | UZ - FISH-HOOK W/CIRCLE STRAIGHT ARROW (90 MIL) |
| UG - COMBO. LEFT/RIGHT/STRAIGHT ARROW (90 MIL) | |
| UH - HANDICAP PARKING (90 MIL) | WA - FISH-HOOK W/CIRCLE LEFT ARROW (90 MIL) |
| UI - ALPHANUMERIC CHAR. (120 MIL) | WB - FISH-HOOK W/CIRCLE LEFT/STRAIGHT ARROW (90 MIL) |
| UJ - BICYCLE SYMBOL (90 MIL) | WC - FISH-HOOK W/CIRCLE LEFT/RIGHT/STRAIGHT ARROW (90 MIL) |
| UK - BICYCLE STRAIGHT ARROW (90 MIL) | |
| UL - BICYCLE CHAR. (120 MIL) | MA - PERMANENT RAISED MARKER (YELLOW & YELLOW) |
| UM - 12" YIELD LINE TRIANGLE (90 MIL) | MB - PERMANENT RAISED MARKER (CRYSTAL & RED) |
| UN - 24" YIELD LINE TRIANGLE (90 MIL) | MC - PERMANENT RAISED MARKER (YELLOW & RED) |
| UO - BICYCLE LEFT ARROW (90 MIL) | MD - PERMANENT RAISED MARKER (YELLOW) |
| UP - MERGE ARROW (90 MIL) | ME - SNOWPLOWABLE MARKER (YELLOW & YELLOW) |
| UQ - RAMP ARROW SYMBOL (90 MIL) | MF - SNOWPLOWABLE MARKER (CRYSTAL & RED) |
| UR - SHARROW (90 MIL) | MG - SNOWPLOWABLE MARKER (YELLOW & RED) |
| US - BICYCLE LOOP DETECTOR (90 MIL) | ML - PERMANENT RAISED MARKER (CRYSTAL & CRYSTAL) |
| UT - U-TURN ARROW (90 MIL) | MO - SNOWPLOWABLE MARKER (CRYSTAL & CRYSTAL) |

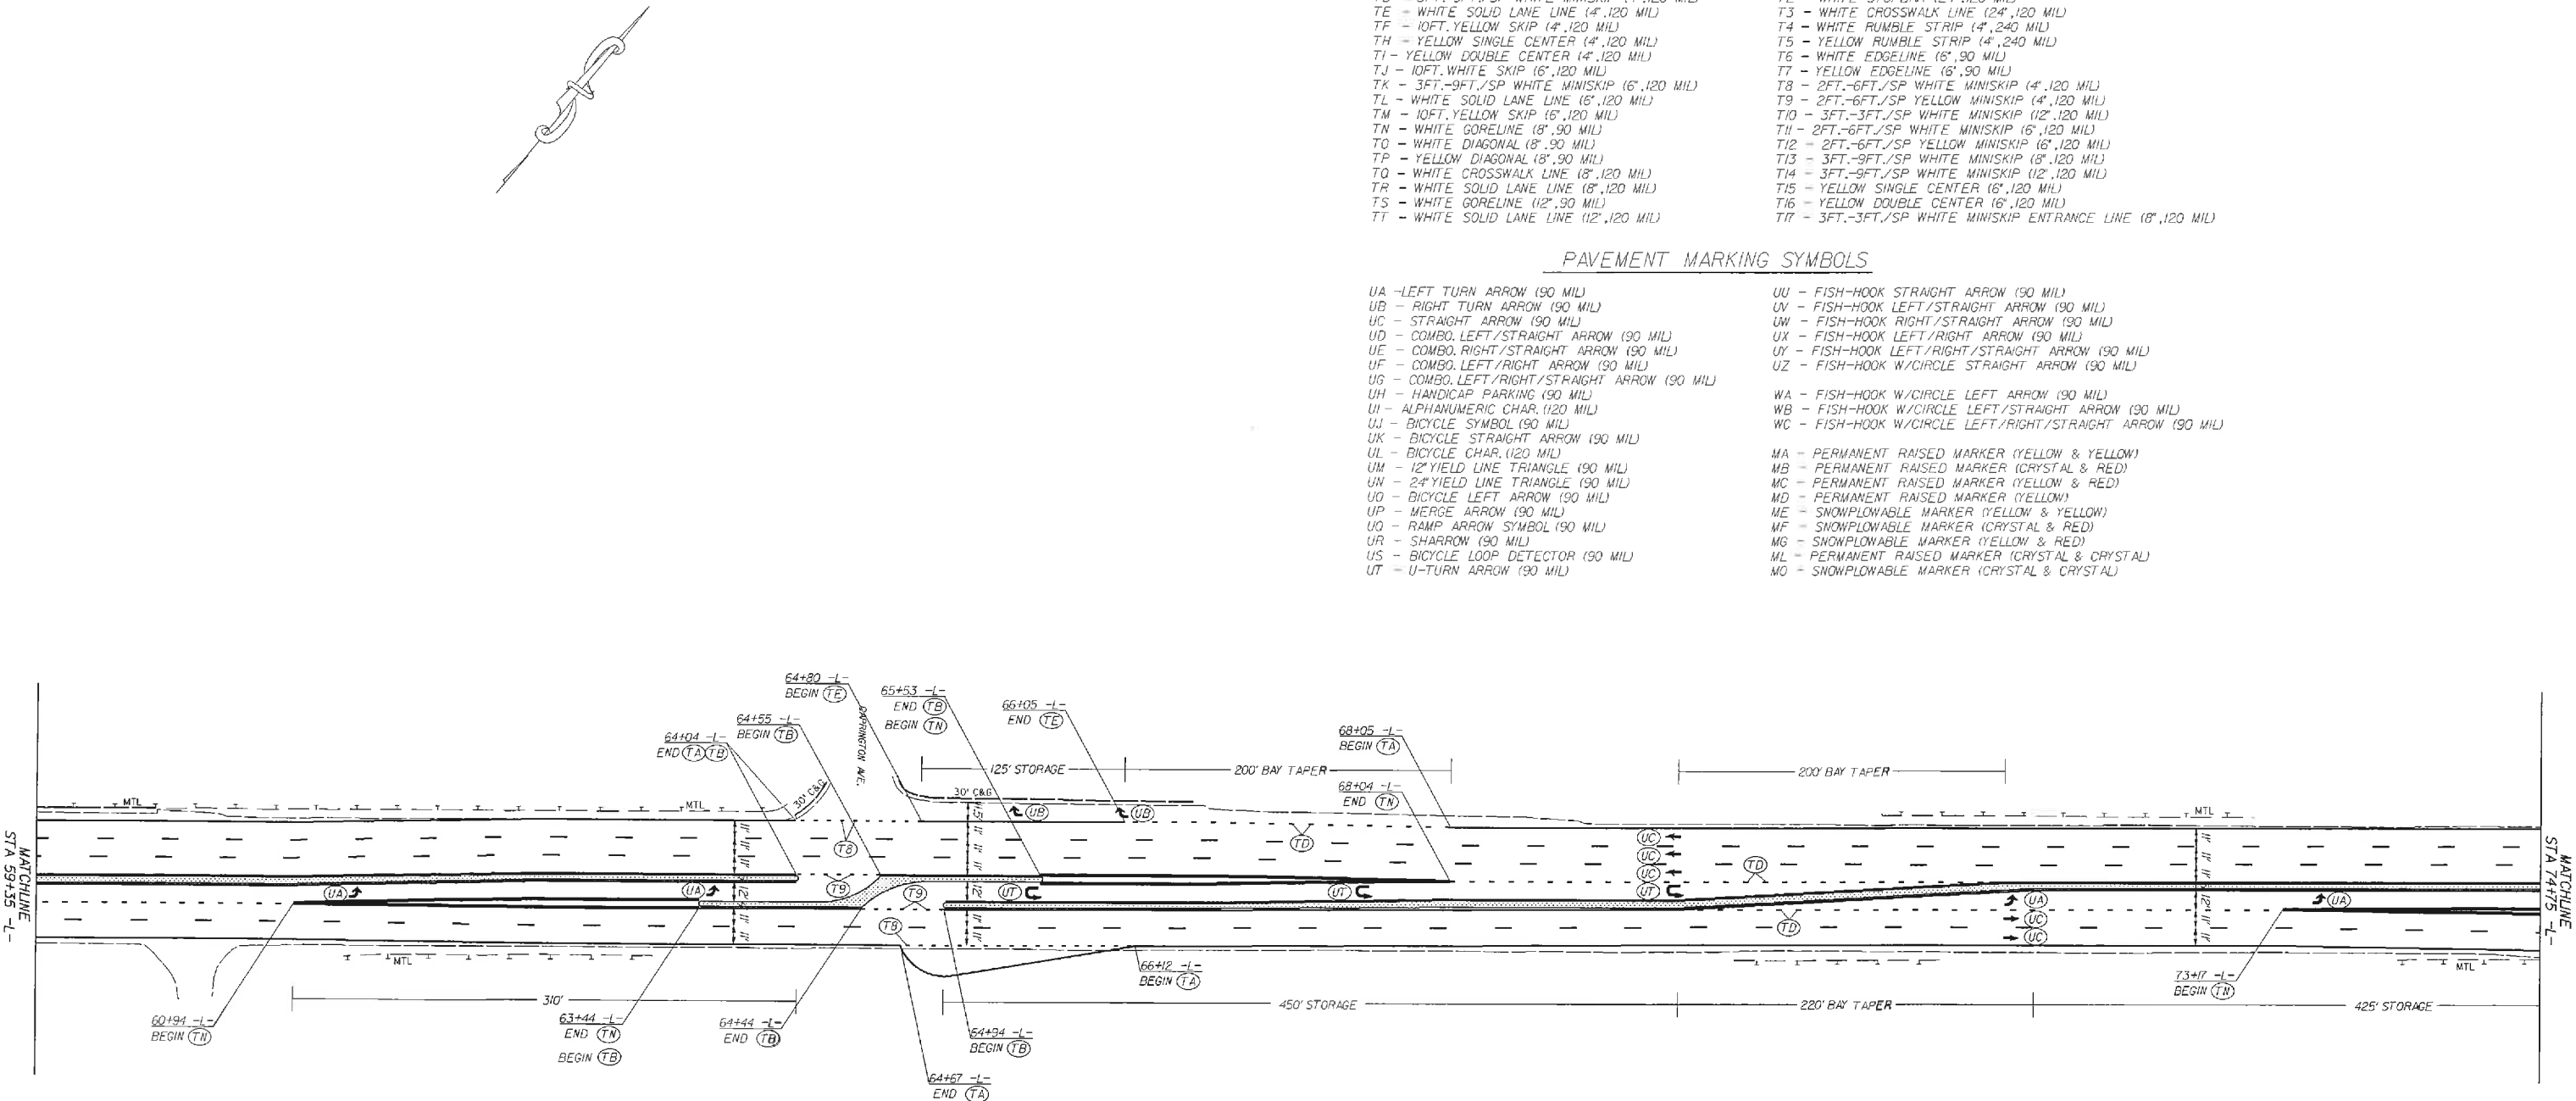

US 29 FROM PAVILLION BLVD. TO
BRUTON SMITH BLVD

SCALE	1"=50'
DATE	04/14
DWG. BY	TWB
DESIGN BY	TWB
APPROVED	RWB



REVISIONS

STATE	PROJECT NO.	SHEET NO.	TOTAL SHEETS
N.C.	45340.3FR8	PMP-5	
F.A. PROJECT NO.		HSIP-0029601	


PAVEMENT MARKING SCHEDULE

PAVEMENT MARKING LINES

- | | |
|--|---|
| TA - WHITE EDGE LINE (4', 90 MIL) | TU - WHITE DIAGONAL (12', 90 MIL) |
| TB - YELLOW EDGE LINE (4', 90 MIL) | TV - YELLOW DIAGONAL (12', 90 MIL) |
| TC - 10FT. WHITE SKIP (4', 120 MIL) | TI - WHITE LINE, RR X (16', 120 MIL) |
| TD - 3FT.-9FT./SP WHITE MINISKIP (4', 120 MIL) | T2 - WHITE STOPBAR (24', 120 MIL) |
| TE - WHITE SOLID LANE LINE (4', 120 MIL) | T3 - WHITE CROSSWALK LINE (24', 120 MIL) |
| TF - 10FT. YELLOW SKIP (4', 120 MIL) | T4 - WHITE RUMBLE STRIP (4', 240 MIL) |
| TH - YELLOW SINGLE CENTER (4', 120 MIL) | T5 - YELLOW RUMBLE STRIP (4', 240 MIL) |
| TJ - YELLOW DOUBLE CENTER (4', 120 MIL) | T6 - WHITE EDGE LINE (6', 90 MIL) |
| TK - 10FT. WHITE SKIP (6', 120 MIL) | T7 - YELLOW EDGE LINE (6', 90 MIL) |
| TL - WHITE SOLID LANE LINE (6', 120 MIL) | T8 - 2FT.-6FT./SP WHITE MINISKIP (4', 120 MIL) |
| TM - 10FT. YELLOW SKIP (6', 120 MIL) | T9 - 2FT.-6FT./SP YELLOW MINISKIP (4', 120 MIL) |
| TN - WHITE GORELINE (8', 90 MIL) | T10 - 3FT.-3FT./SP WHITE MINISKIP (12', 120 MIL) |
| TO - WHITE DIAGONAL (8', 90 MIL) | T11 - 2FT.-6FT./SP WHITE MINISKIP (6', 120 MIL) |
| TP - YELLOW DIAGONAL (8', 90 MIL) | T12 - 2FT.-6FT./SP YELLOW MINISKIP (6', 120 MIL) |
| TQ - WHITE CROSSWALK LINE (8', 120 MIL) | T13 - 3FT.-9FT./SP WHITE MINISKIP (8', 120 MIL) |
| TR - WHITE SOLID LANE LINE (8', 120 MIL) | T14 - 3FT.-9FT./SP WHITE MINISKIP (12', 120 MIL) |
| TS - WHITE GORELINE (12', 90 MIL) | T15 - YELLOW SINGLE CENTER (6', 120 MIL) |
| TT - WHITE SOLID LANE LINE (12', 120 MIL) | T16 - YELLOW DOUBLE CENTER (6', 120 MIL) |
| | T17 - 3FT.-3FT./SP WHITE MINISKIP ENTRANCE LINE (8', 120 MIL) |

PAVEMENT MARKING SYMBOLS

- | | |
|--|--|
| UA - LEFT TURN ARROW (90 MIL) | UU - FISH-HOOK STRAIGHT ARROW (90 MIL) |
| UB - RIGHT TURN ARROW (90 MIL) | UV - FISH-HOOK LEFT/STRAIGHT ARROW (90 MIL) |
| UC - STRAIGHT ARROW (90 MIL) | UW - FISH-HOOK RIGHT/STRAIGHT ARROW (90 MIL) |
| UD - COMBO. LEFT/STRAIGHT ARROW (90 MIL) | UX - FISH-HOOK LEFT/RIGHT ARROW (90 MIL) |
| UE - COMBO. RIGHT/STRAIGHT ARROW (90 MIL) | UY - FISH-HOOK LEFT/RIGHT/STRAIGHT ARROW (90 MIL) |
| UF - COMBO. LEFT/RIGHT ARROW (90 MIL) | UZ - FISH-HOOK W/CIRCLE STRAIGHT ARROW (90 MIL) |
| UG - COMBO. LEFT/RIGHT/STRAIGHT ARROW (90 MIL) | |
| UH - HANDICAP PARKING (90 MIL) | WA - FISH-HOOK W/CIRCLE LEFT ARROW (90 MIL) |
| UI - ALPHANUMERIC CHAR. (120 MIL) | WB - FISH-HOOK W/CIRCLE LEFT/STRAIGHT ARROW (90 MIL) |
| UJ - BICYCLE SYMBOL (90 MIL) | WC - FISH-HOOK W/CIRCLE LEFT/RIGHT/STRAIGHT ARROW (90 MIL) |
| UK - BICYCLE STRAIGHT ARROW (90 MIL) | |
| UL - BICYCLE CHAR. (120 MIL) | MA - PERMANENT RAISED MARKER (YELLOW & YELLOW) |
| UM - 12" YIELD LINE TRIANGLE (90 MIL) | MB - PERMANENT RAISED MARKER (CRYSTAL & RED) |
| UN - 24" YIELD LINE TRIANGLE (90 MIL) | MC - PERMANENT RAISED MARKER (YELLOW & RED) |
| UO - BICYCLE LEFT ARROW (90 MIL) | MD - PERMANENT RAISED MARKER (YELLOW) |
| UP - MERGE ARROW (90 MIL) | ME - SNOWPLOWABLE MARKER (YELLOW & YELLOW) |
| UQ - RAMP ARROW SYMBOL (90 MIL) | MF - SNOWPLOWABLE MARKER (CRYSTAL & RED) |
| UR - SHARROW (90 MIL) | MG - SNOWPLOWABLE MARKER (YELLOW & RED) |
| US - BICYCLE LOOP DETECTOR (90 MIL) | ML - PERMANENT RAISED MARKER (CRYSTAL & CRYSTAL) |
| UT - U-TURN ARROW (90 MIL) | MO - SNOWPLOWABLE MARKER (CRYSTAL & CRYSTAL) |

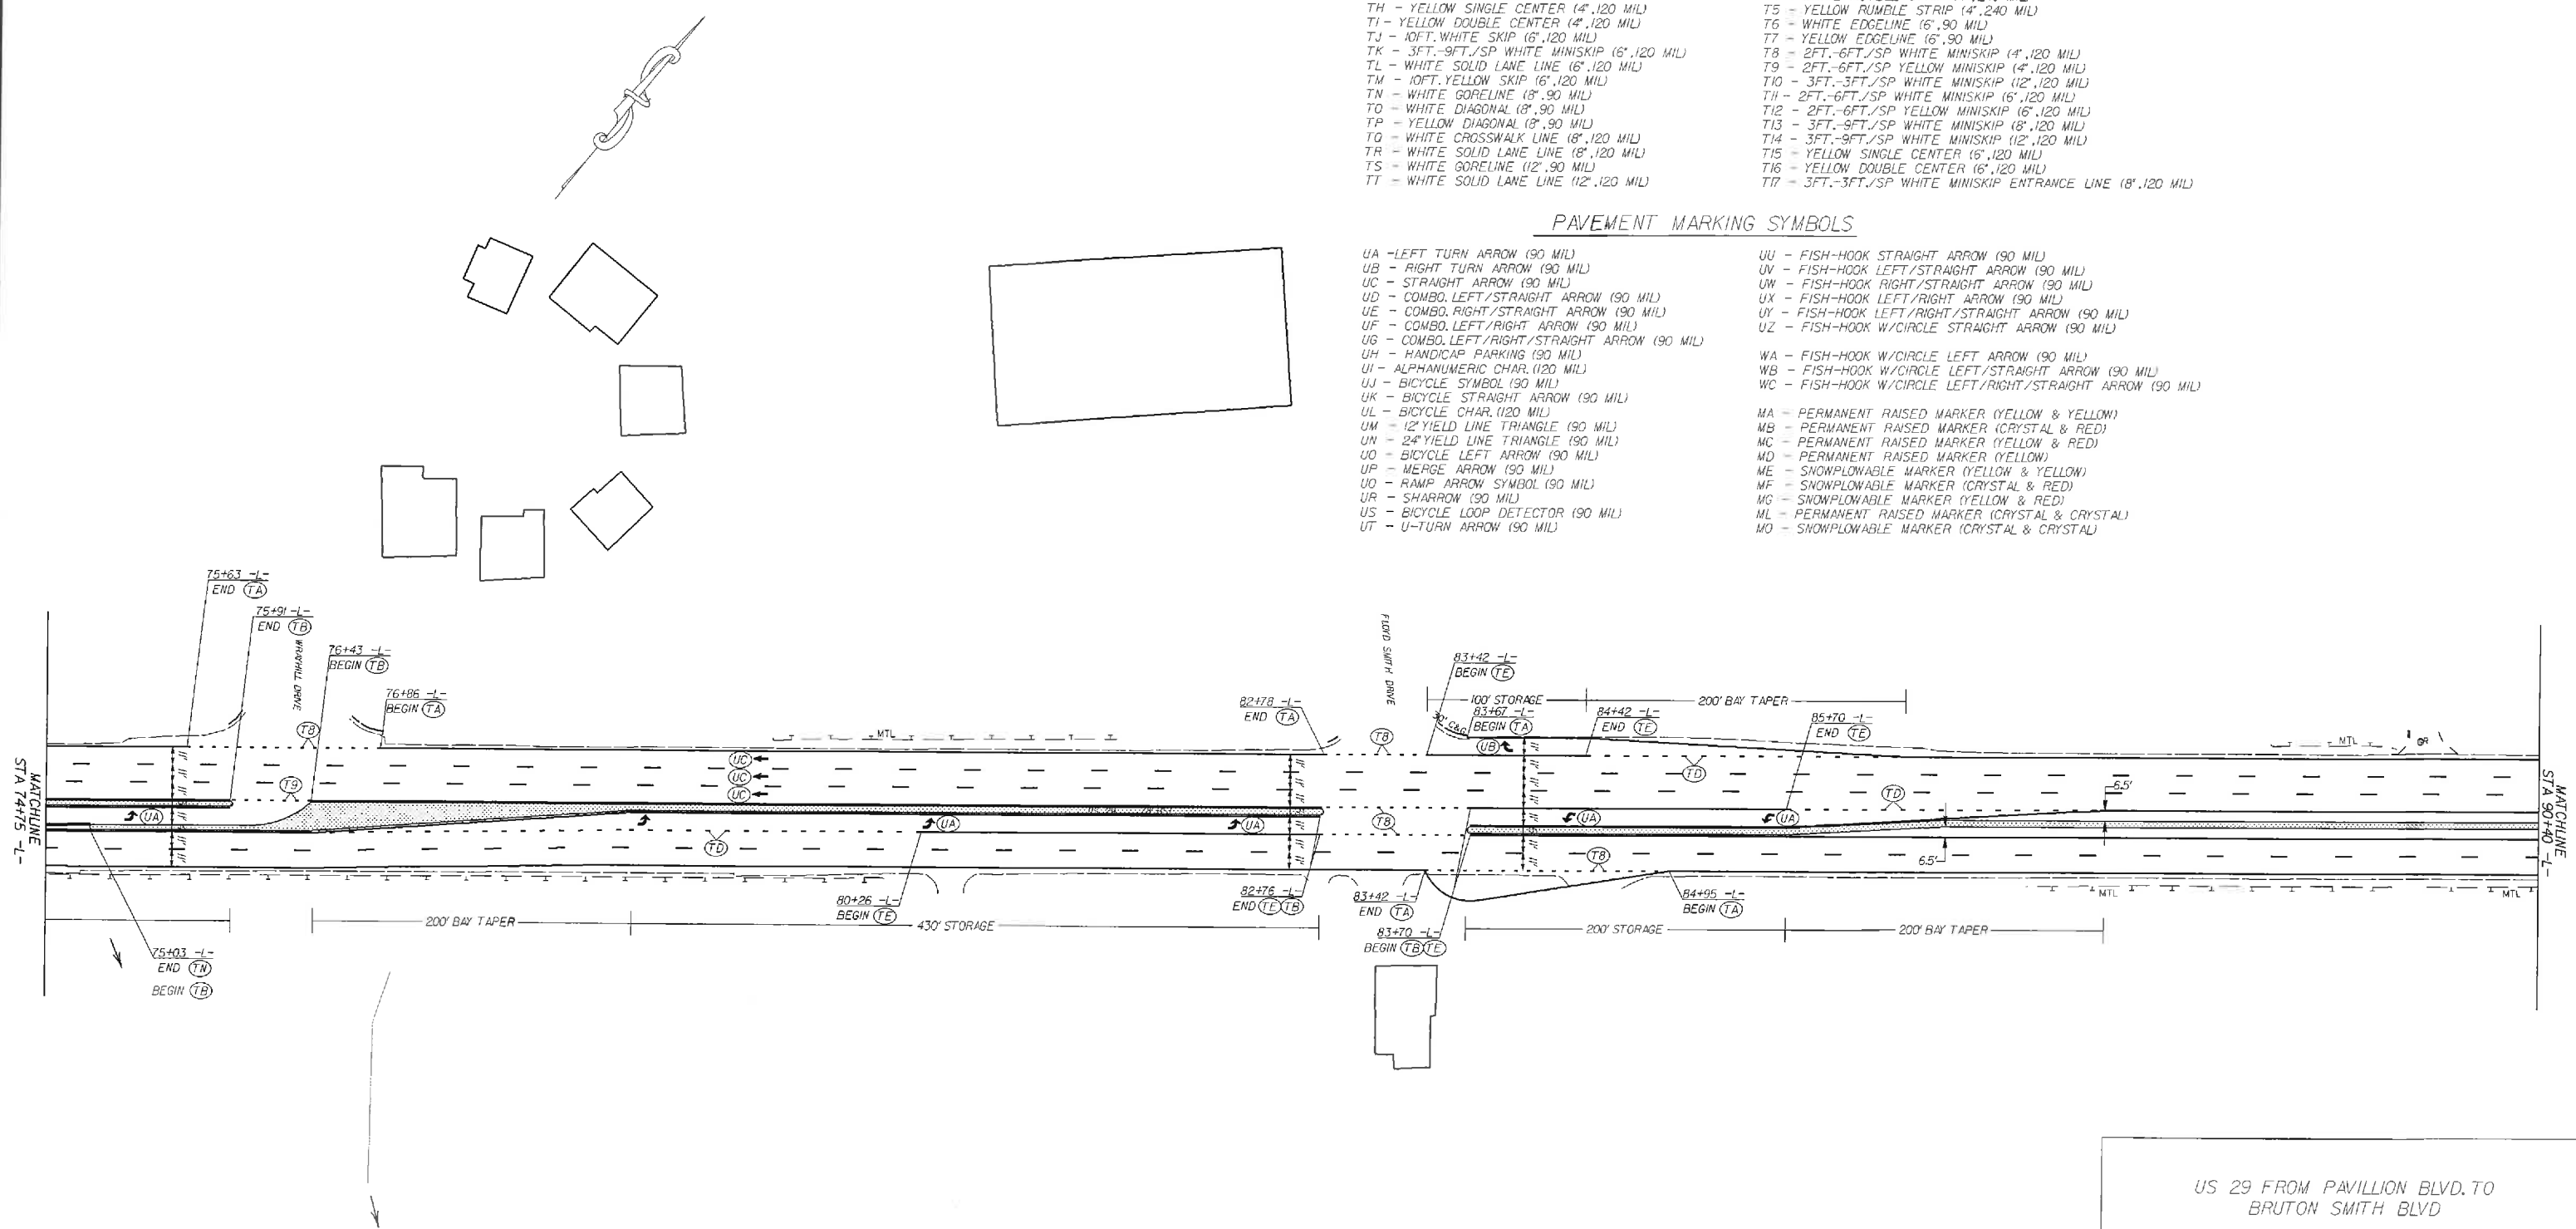

US 29 FROM PAVILLION BLVD. TO
BRUTON SMITH BLVD

SCALE	1"=50'		REVISIONS
DATE	04/14		
DWG. BY	TWB		
DESIGN BY	TWB		
APPROVED	RWB		

PAVEMENT MARKING SCHEDULE


STATE	PROJECT NO.	SHEET NO.	TOTAL SHEETS
N.C.	45340.3.FRB	PMP-6	
F.A. PROJECT NO.		HSIP-0029(60)	

PAVEMENT MARKING LINES

- | | |
|--|---|
| TA - WHITE EDGELINE (4',.90 MIL) | TU - WHITE DIAGONAL (12',.90 MIL) |
| TB - YELLOW EDGELINE (4',.90 MIL) | TV - YELLOW DIAGONAL (12',.90 MIL) |
| TC - 10FT. WHITE SKIP (4',.120 MIL) | T1 - WHITE LINE, RR X (16',.120 MIL) |
| TD - 3FT.-9FT./SP WHITE MINISKIP (4',.120 MIL) | T2 - WHITE STOPBAR (24',.120 MIL) |
| TE - WHITE SOLID LANE LINE (4',.120 MIL) | T3 - WHITE CROSSWALK LINE (24',.120 MIL) |
| TF - 10FT. YELLOW SKIP (4',.120 MIL) | T4 - WHITE RUMBLE STRIP (4",.240 MIL) |
| TH - YELLOW SINGLE CENTER (4',.120 MIL) | T5 - YELLOW RUMBLE STRIP (4",.240 MIL) |
| TI - YELLOW DOUBLE CENTER (4',.120 MIL) | T6 - WHITE EDGELINE (6',.90 MIL) |
| TJ - 10FT. WHITE SKIP (6',.120 MIL) | T7 - YELLOW EDGELINE (6',.90 MIL) |
| TK - 3FT.-9FT./SP WHITE MINISKIP (6',.120 MIL) | T8 - 2FT.-6FT./SP WHITE MINISKIP (4',.120 MIL) |
| TL - WHITE SOLID LANE LINE (6',.120 MIL) | T9 - 2FT.-6FT./SP YELLOW MINISKIP (4',.120 MIL) |
| TM - 10FT. YELLOW SKIP (6',.120 MIL) | T10 - 3FT.-3FT./SP WHITE MINISKIP (12',.120 MIL) |
| TN - WHITE GORELINE (8',.90 MIL) | T11 - 2FT.-6FT./SP WHITE MINISKIP (6',.120 MIL) |
| TO - WHITE DIAGONAL (8',.90 MIL) | T12 - 2FT.-6FT./SP YELLOW MINISKIP (6',.120 MIL) |
| TP - YELLOW DIAGONAL (8',.90 MIL) | T13 - 3FT.-9FT./SP WHITE MINISKIP (8',.120 MIL) |
| TQ - WHITE CROSSWALK LINE (8',.120 MIL) | T14 - 3FT.-9FT./SP WHITE MINISKIP (12',.120 MIL) |
| TR - WHITE SOLID LANE LINE (8',.120 MIL) | T15 - YELLOW SINGLE CENTER (6',.120 MIL) |
| TS - WHITE GORELINE (12',.90 MIL) | T16 - YELLOW DOUBLE CENTER (6',.120 MIL) |
| TT - WHITE SOLID LANE LINE (12',.120 MIL) | T17 - 3FT.-3FT./SP WHITE MINISKIP ENTRANCE LINE (8',.120 MIL) |

PAVEMENT MARKING SYMBOLS

- | | |
|--|--|
| UA - LEFT TURN ARROW (90 MIL) | UU - FISH-HOOK STRAIGHT ARROW (90 MIL) |
| UB - RIGHT TURN ARROW (90 MIL) | UV - FISH-HOOK LEFT/STRAIGHT ARROW (90 MIL) |
| UC - STRAIGHT ARROW (90 MIL) | UX - FISH-HOOK RIGHT/STRAIGHT ARROW (90 MIL) |
| UD - COMBO. LEFT/STRAIGHT ARROW (90 MIL) | UY - FISH-HOOK LEFT/RIGHT ARROW (90 MIL) |
| UE - COMBO. RIGHT/STRAIGHT ARROW (90 MIL) | UZ - FISH-HOOK LEFT/RIGHT/STRAIGHT ARROW (90 MIL) |
| UF - COMBO. LEFT/RIGHT ARROW (90 MIL) | |
| UG - COMBO. LEFT/RIGHT/STRAIGHT ARROW (90 MIL) | |
| UH - HANDICAP PARKING (90 MIL) | WA - FISH-HOOK W/CIRCLE LEFT ARROW (90 MIL) |
| UI - ALPHANUMERIC CHAR. (120 MIL) | WB - FISH-HOOK W/CIRCLE LEFT/STRAIGHT ARROW (90 MIL) |
| UJ - BICYCLE SYMBOL (90 MIL) | WC - FISH-HOOK W/CIRCLE LEFT/RIGHT/STRAIGHT ARROW (90 MIL) |
| UK - BICYCLE STRAIGHT ARROW (90 MIL) | |
| UL - BICYCLE CHAR. (120 MIL) | MA - PERMANENT RAISED MARKER (YELLOW & YELLOW) |
| UM - 12" YIELD LINE TRIANGLE (90 MIL) | MB - PERMANENT RAISED MARKER (CRYSTAL & RED) |
| UN - 24" YIELD LINE TRIANGLE (90 MIL) | MC - PERMANENT RAISED MARKER (YELLOW & RED) |
| UO - BICYCLE LEFT ARROW (90 MIL) | MD - PERMANENT RAISED MARKER (YELLOW) |
| UP - MERGE ARROW (90 MIL) | ME - SNOWPLOWABLE MARKER (YELLOW & YELLOW) |
| UQ - RAMP ARROW SYMBOL (90 MIL) | MF - SNOWPLOWABLE MARKER (CRYSTAL & RED) |
| UR - SHARROW (90 MIL) | MG - SNOWPLOWABLE MARKER (YELLOW & RED) |
| US - BICYCLE LOOP DETECTOR (90 MIL) | ML - PERMANENT RAISED MARKER (CRYSTAL & CRYSTAL) |
| UT - U-TURN ARROW (90 MIL) | MO - SNOWPLOWABLE MARKER (CRYSTAL & CRYSTAL) |

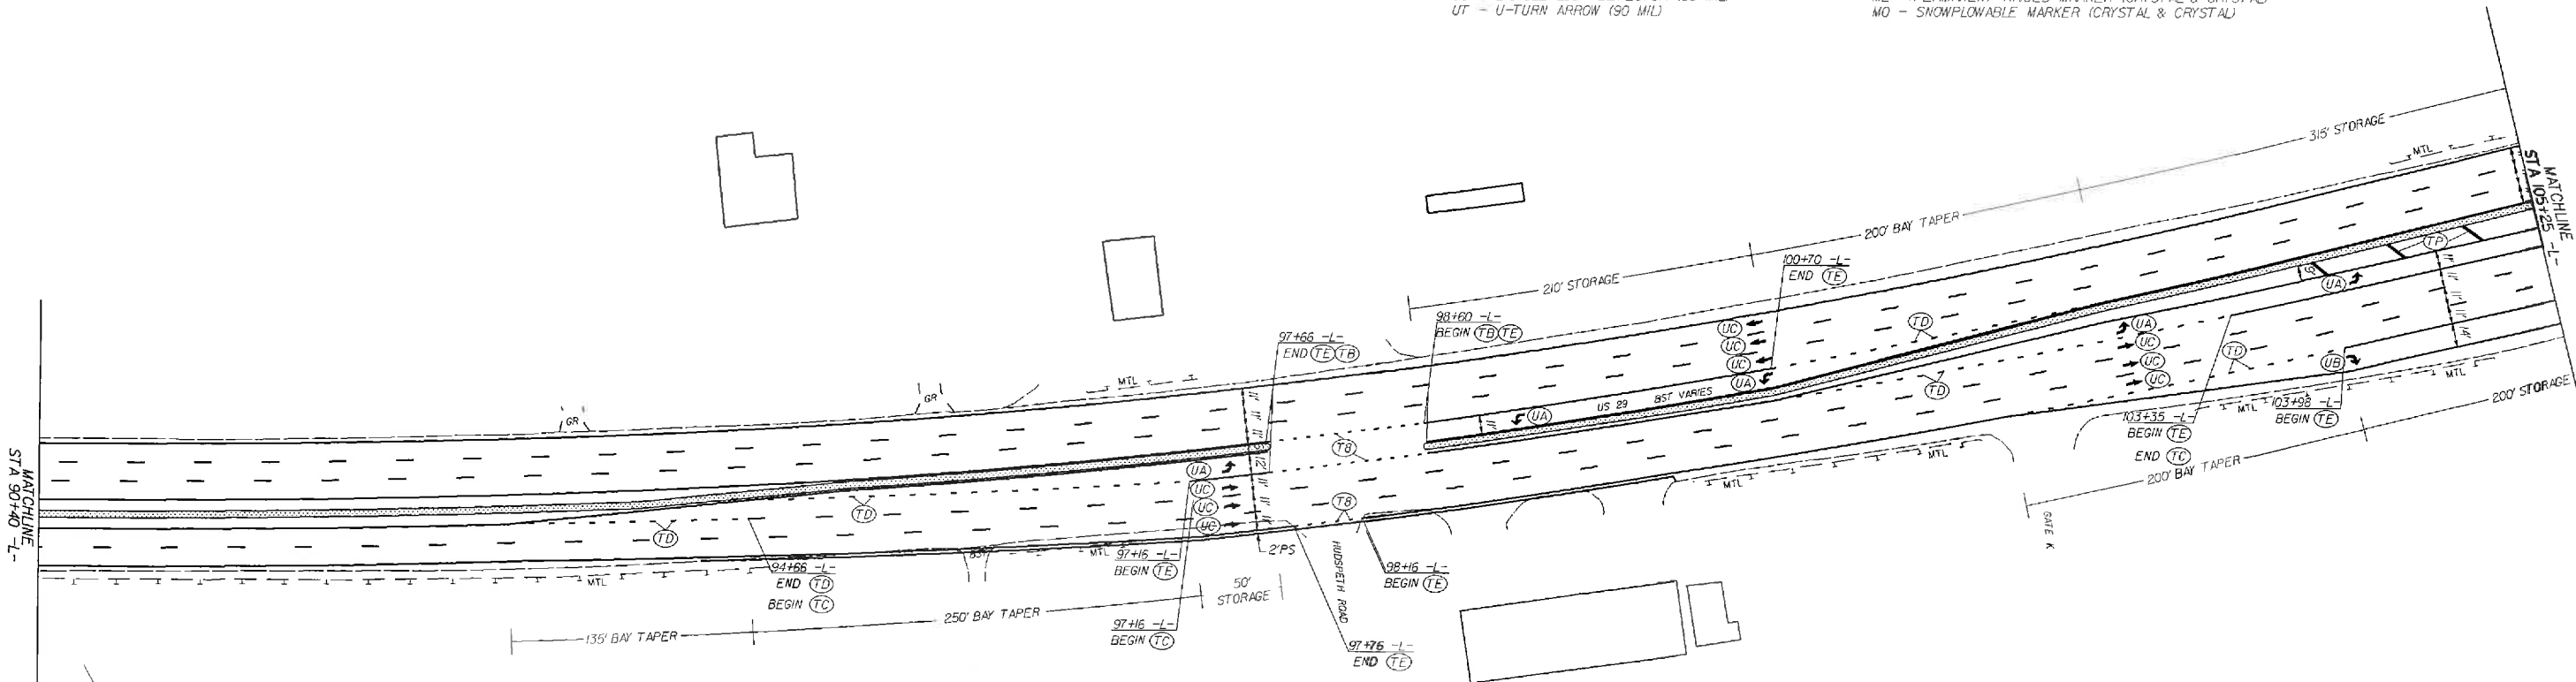

US 29 FROM PAVILLION BLVD. TO BRUTON SMITH BLVD

SCALE	1"=50'		REVISIONS
DATE	04/14		
DWG. BY	TWB		
DESIGN BY	TWB		
APPROVED	RWB		

STATE	PROJECT NO.	SHEET NO.	TOTAL SHEETS
N.C.	45340JFRB	PMP-7	
F.A. PROJECT NO. HSIP-0029601			


PAVEMENT MARKING SCHEDULE

PAVEMENT MARKING LINES

- | | |
|---|--|
| <ul style="list-style-type: none"> TA - WHITE EDGELINE (4',.90 MIL) TB - YELLOW EDGELINE (4',.90 MIL) TC - 10FT. WHITE SKIP (4',.120 MIL) TD - 3FT.-9FT./SP WHITE MINISKIP (4',.120 MIL) TE - WHITE SOLID LANE LINE (4',.120 MIL) TF - 10FT. YELLOW SKIP (4',.120 MIL) TH - YELLOW SINGLE CENTER (4',.120 MIL) TI - YELLOW DOUBLE CENTER (4',.120 MIL) TJ - 10FT. WHITE SKIP (6',.120 MIL) TK - 3FT.-9FT./SP WHITE MINISKIP (6',.120 MIL) TL - WHITE SOLID LANE LINE (6',.120 MIL) TM - 10FT. YELLOW SKIP (6',.120 MIL) TN - WHITE GORELINE (8',.90 MIL) TO - WHITE DIAGONAL (8',.90 MIL) TP - YELLOW DIAGONAL (8',.90 MIL) TG - WHITE CROSSWALK LINE (8',.120 MIL) TR - WHITE SOLID LANE LINE (8',.120 MIL) TS - WHITE GORELINE (12',.90 MIL) TT - WHITE SOLID LANE LINE (12',.120 MIL) | <ul style="list-style-type: none"> TU - WHITE DIAGONAL (12',.90 MIL) TV - YELLOW DIAGONAL (12',.90 MIL) T1 - WHITE LINE, RR X (16',.120 MIL) T2 - WHITE STOPBAR (24',.120 MIL) T3 - WHITE CROSSWALK LINE (24',.120 MIL) T4 - WHITE RUMBLE STRIP (4',.240 MIL) T5 - YELLOW RUMBLE STRIP (4',.240 MIL) T6 - WHITE EDGELINE (6',.90 MIL) T7 - YELLOW EDGELINE (6',.90 MIL) T8 - 2FT.-6FT./SP WHITE MINISKIP (4',.120 MIL) T9 - 2FT.-6FT./SP YELLOW MINISKIP (4',.120 MIL) T10 - 3FT.-3FT./SP WHITE MINISKIP (12',.120 MIL) T11 - 2FT.-6FT./SP WHITE MINISKIP (6',.120 MIL) T12 - 2FT.-6FT./SP YELLOW MINISKIP (6',.120 MIL) T13 - 3FT.-9FT./SP WHITE MINISKIP (18',.120 MIL) T14 - 3FT.-9FT./SP WHITE MINISKIP (12',.120 MIL) T15 - YELLOW SINGLE CENTER (6',.120 MIL) T16 - YELLOW DOUBLE CENTER (6',.120 MIL) T17 - 3FT.-3FT./SP WHITE MINISKIP ENTRANCE LINE (18',.120 MIL) |
|---|--|

PAVEMENT MARKING SYMBOLS

- | | |
|--|---|
| <ul style="list-style-type: none"> UA - LEFT TURN ARROW (90 MIL) UB - RIGHT TURN ARROW (90 MIL) UC - STRAIGHT ARROW (90 MIL) UD - COMBO. LEFT/STRAIGHT ARROW (90 MIL) UE - COMBO. RIGHT/STRAIGHT ARROW (90 MIL) UF - COMBO. LEFT/RIGHT ARROW (90 MIL) UG - COMBO. LEFT/RIGHT/STRAIGHT ARROW (90 MIL) UH - HANDICAP PARKING (90 MIL) UI - ALPHANUMERIC CHAR. (120 MIL) UJ - BICYCLE SYMBOL (90 MIL) UK - BICYCLE STRAIGHT ARROW (90 MIL) UL - BICYCLE CHAR. (120 MIL) UM - 12" YIELD LINE TRIANGLE (90 MIL) UN - 24" YIELD LINE TRIANGLE (90 MIL) UO - BICYCLE LEFT ARROW (90 MIL) UP - MERGE ARROW (90 MIL) UQ - RAMP ARROW SYMBOL (90 MIL) UR - SHARROW (90 MIL) US - BICYCLE LOOP DETECTOR (90 MIL) UT - U-TURN ARROW (90 MIL) | <ul style="list-style-type: none"> UU - FISH-HOOK STRAIGHT ARROW (90 MIL) UV - FISH-HOOK LEFT/STRAIGHT ARROW (90 MIL) UW - FISH-HOOK RIGHT/STRAIGHT ARROW (90 MIL) UX - FISH-HOOK LEFT/RIGHT ARROW (90 MIL) UY - FISH-HOOK LEFT/RIGHT/STRAIGHT ARROW (90 MIL) UZ - FISH-HOOK W/CIRCLE STRAIGHT ARROW (90 MIL) WA - FISH-HOOK W/CIRCLE LEFT ARROW (90 MIL) WB - FISH-HOOK W/CIRCLE LEFT/STRAIGHT ARROW (90 MIL) WC - FISH-HOOK W/CIRCLE LEFT/RIGHT/STRAIGHT ARROW (90 MIL) MA - PERMANENT RAISED MARKER (YELLOW & YELLOW) MB - PERMANENT RAISED MARKER (CRYSTAL & RED) MC - PERMANENT RAISED MARKER (YELLOW & RED) MD - PERMANENT RAISED MARKER (YELLOW) ME - SNOWPLOWABLE MARKER (YELLOW & YELLOW) MF - SNOWPLOWABLE MARKER (CRYSTAL & RED) MG - SNOWPLOWABLE MARKER (YELLOW & RED) ML - PERMANENT RAISED MARKER (CRYSTAL & CRYSTAL) MO - SNOWPLOWABLE MARKER (CRYSTAL & CRYSTAL) |
|--|---|

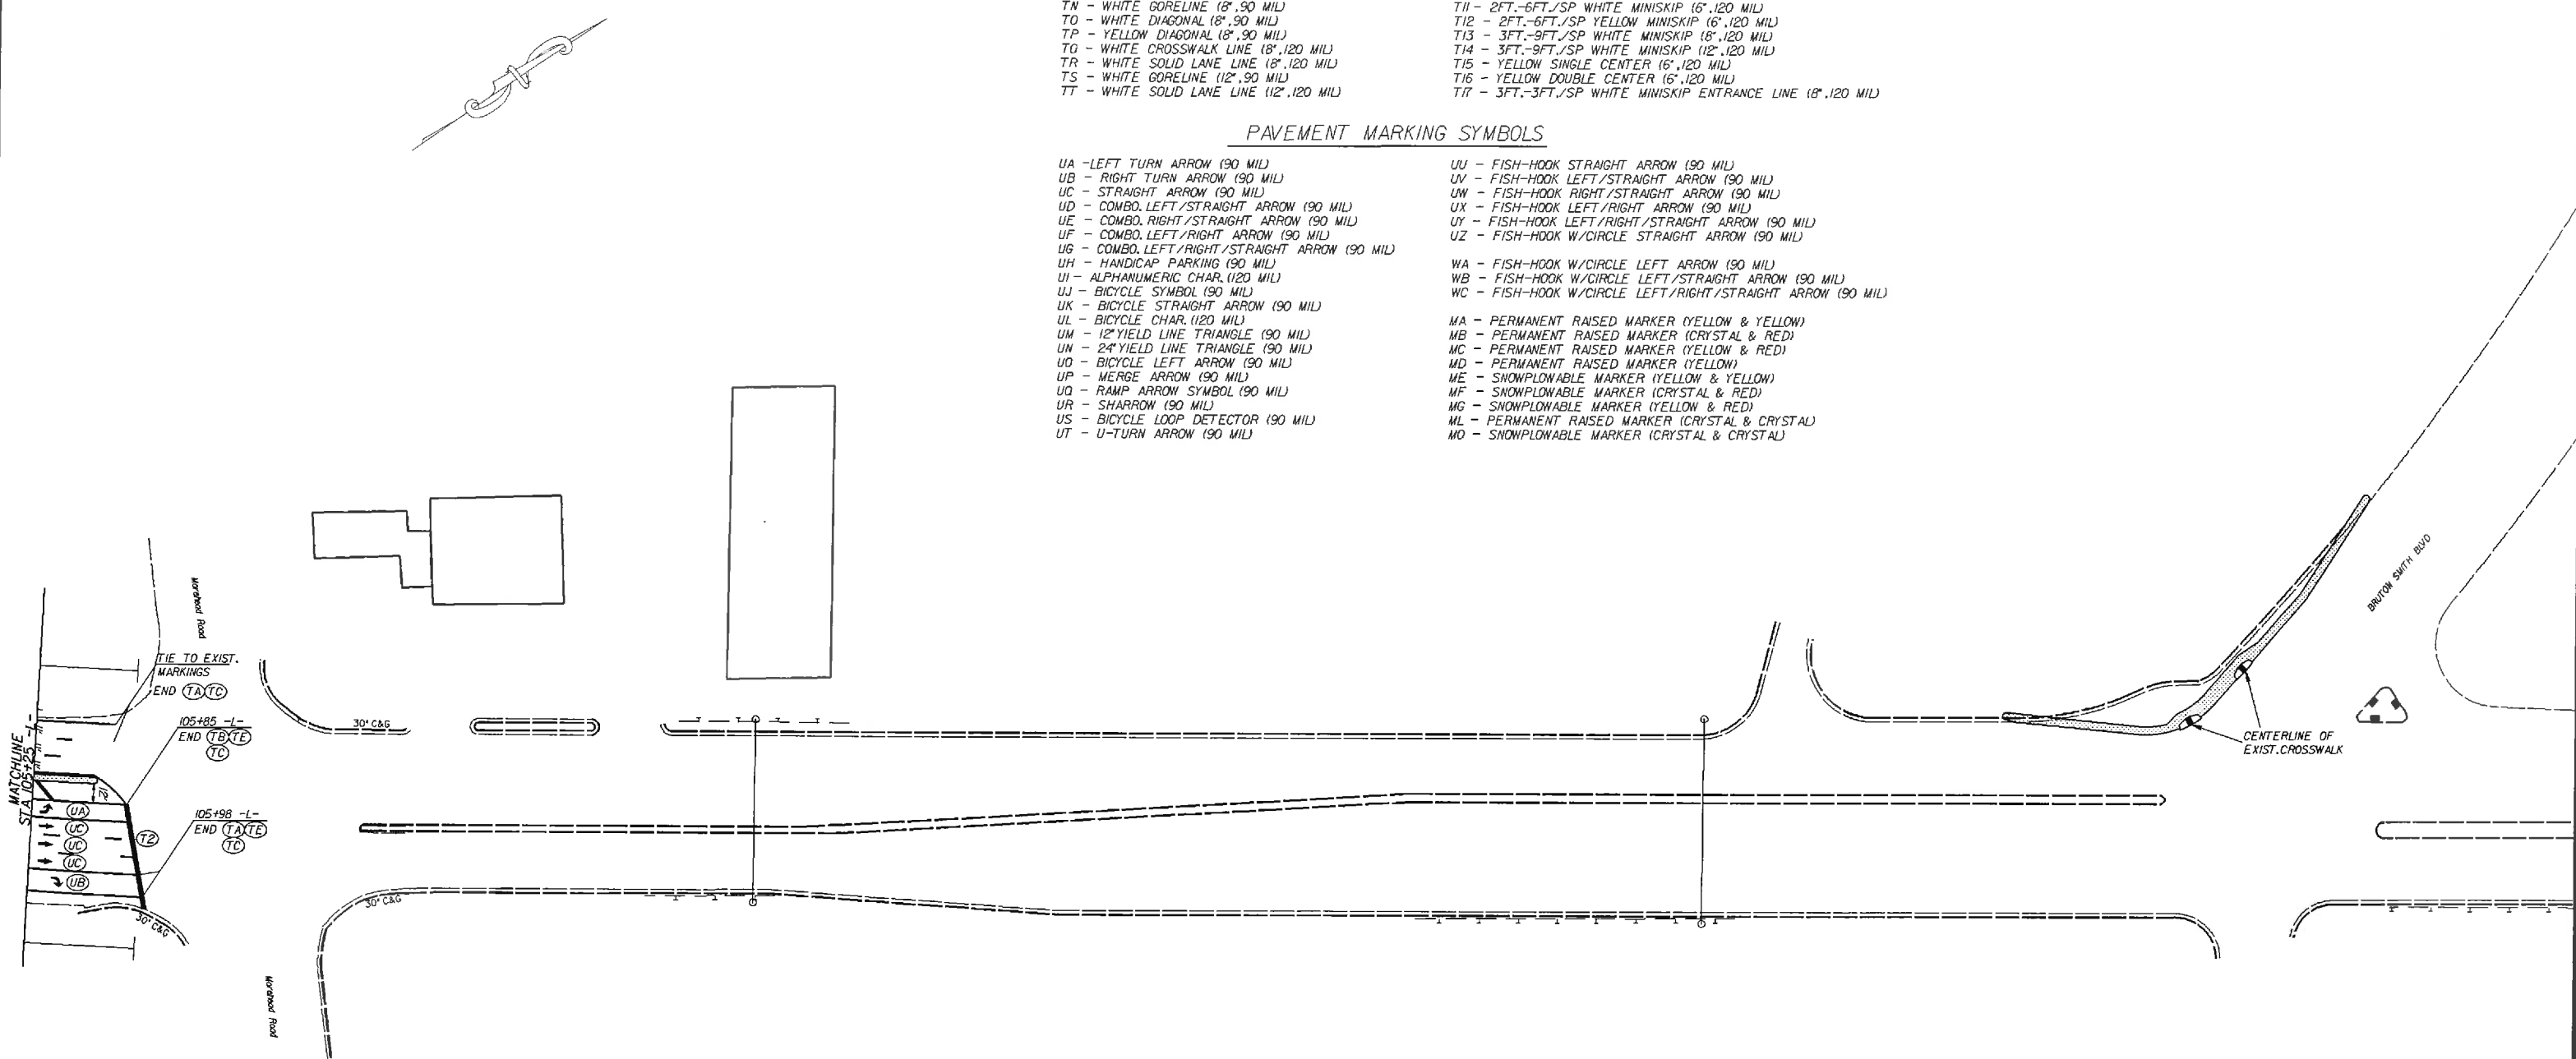


US 29 FROM PAVILLION BLVD. TO
BRUTON SMITH BLVD

SCALE	1"=50'		REVISIONS
DATE	04/14		
DWG. BY	TWB		
DESIGN BY	TWB		
APPROVED	RWB		

PROJECT: 45340.3.FR8 TIP: W-5210H

STATE OF NORTH CAROLINA
 DIVISION OF HIGHWAYS
 PLAN FOR PROPOSED
 HIGHWAY EROSION CONTROL


STATE	STATE PROJECT REFERENCE NO.	SHEET NO.	TOTAL SHEETS
N.C.	W-5210H	EC-1	
STATE PROJ. NO.	F.A. PROJ. NO.	DESCRIPTION	

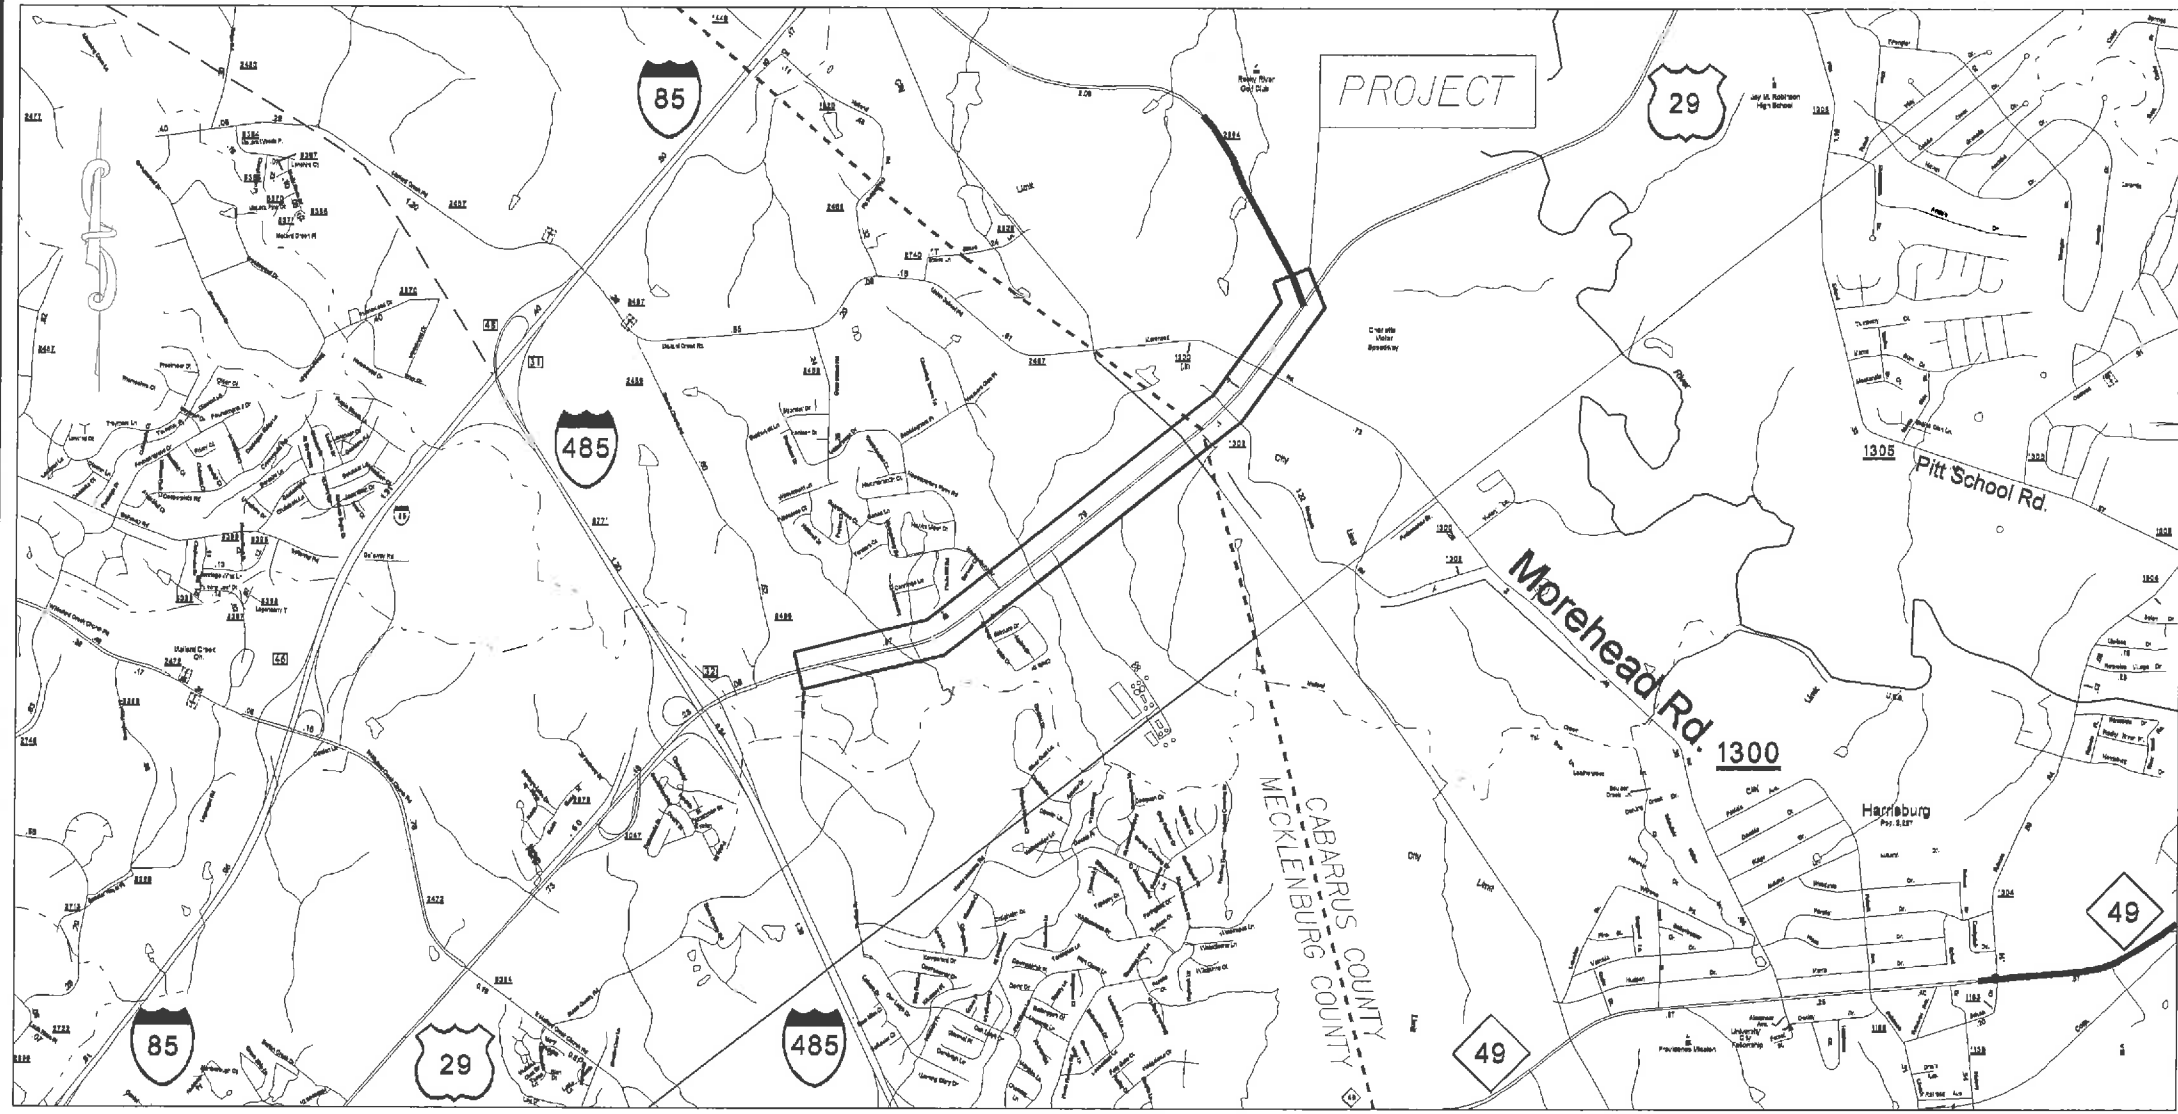

EROSION AND SEDIMENT CONTROL MEASURES

Std. #	Description	Symbol
1630.03	Temporary Silt Ditch	TD
1630.05	Temporary Diversion	TD
1605.01	Temporary Silt Fence	III III III
1606.01	Special Sediment Control Fence	III III III
1622.01	Temporary Berms and Slope Drains	--- ---
1630.02	Silt Basin Type B	--- ---
1633.01	Temporary Rock Silt Check Type-A	--- ---
	Temporary Rock Silt Check Type-A with Matting and Polyacrylamide (PAM)	--- ---
1633.02	Temporary Rock Silt Check Type-B	--- ---
	Wattle / Coir Fiber Wattle	--- ---
	Wattle / Coir Fiber Wattle with Polyacrylamide (PAM)	--- ---
1634.01	Temporary Rock Sediment Dam Type-A	--- ---
1634.02	Temporary Rock Sediment Dam Type-B	--- ---
1635.01	Rock Pipe Inlet Sediment Trap Type-A	--- ---
1635.02	Rock Pipe Inlet Sediment Trap Type-B	--- ---
1630.04	Stilling Basin	--- ---
1630.06	Special Stilling Basin	--- ---
	Rock Inlet Sediment Trap:	
1632.01	Type A	A
1632.02	Type B	B
1632.03	Type C	C
	Skimmer Basin	--- ---
	Tiered Skimmer Basin	--- ---
	Infiltration Basin	--- ---

THIS PROJECT CONTAINS EROSION CONTROL PLANS FOR CLEARING AND GRUBBING PHASE OF CONSTRUCTION.

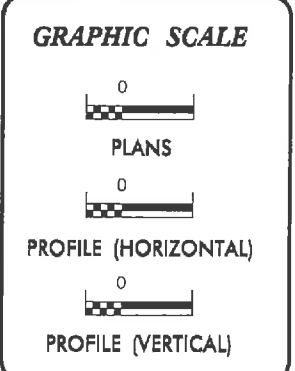

ROADSIDE ENVIRONMENTAL UNIT
 DIVISION OF HIGHWAYS
 STATE OF NORTH CAROLINA

THESE EROSION AND SEDIMENT CONTROL PLANS COMPLY WITH THE REGULATIONS SET FORTH BY THE NCG-010000 GENERAL CONSTRUCTION PERMIT EFFECTIVE AUGUST 3, 2011 ISSUED BY THE NORTH CAROLINA DEPARTMENT OF ENVIRONMENT AND NATURAL RESOURCES DIVISION OF WATER QUALITY.

Prepared in the Office of:
DDC UNIT DIVISION 10
 DEPARTMENT OF TRANSPORTATION
 DIVISION OF HIGHWAYS
2012 STANDARD SPECIFICATIONS

DONALD HARWARD
 EROSION CONTROL DESIGNER

3028
 LEVEL III-A CERTIFICATION #


Roadway Standard Drawings

The following roadway english standards as appear in "Roadway Standard Drawings"- Roadway Design Unit - N. C. Department of Transportation - Raleigh, N. C., dated January 2012 and the latest revision thereto are applicable to this project and by reference hereby are considered a part of these plans.

1604.01 Railroad Erosion Control Detail	1632.01 Rock Inlet Sediment Trap Type A
1605.01 Temporary Silt Fence	1632.02 Rock Inlet Sediment Trap Type B
1606.01 Special Sediment Control Fence	1632.03 Rock Inlet Sediment Trap Type C
1607.01 Gravel Construction Entrance	1633.01 Temporary Rock Silt Check Type A
1622.01 Temporary Berms and Slope Drains	1633.02 Temporary Rock Silt Check Type B
1630.01 Rise Basin	1634.01 Temporary Rock Sediment Dam Type A
1630.02 Silt Basin Type B	1634.02 Temporary Rock Sediment Dam Type B
1630.03 Temporary Silt Ditch	1635.01 Rock Pipe Inlet Sediment Trap Type A
1630.04 Stilling Basin	1635.02 Rock Pipe Inlet Sediment Trap Type B
1630.05 Temporary Diversion	1640.01 Coir Fiber Wattle
1630.06 Special Stilling Basin	1645.01 Temporary Stream Crossing
1631.01 Matting Installation	


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F.A. PROJECT NO. HSIP-0028601			

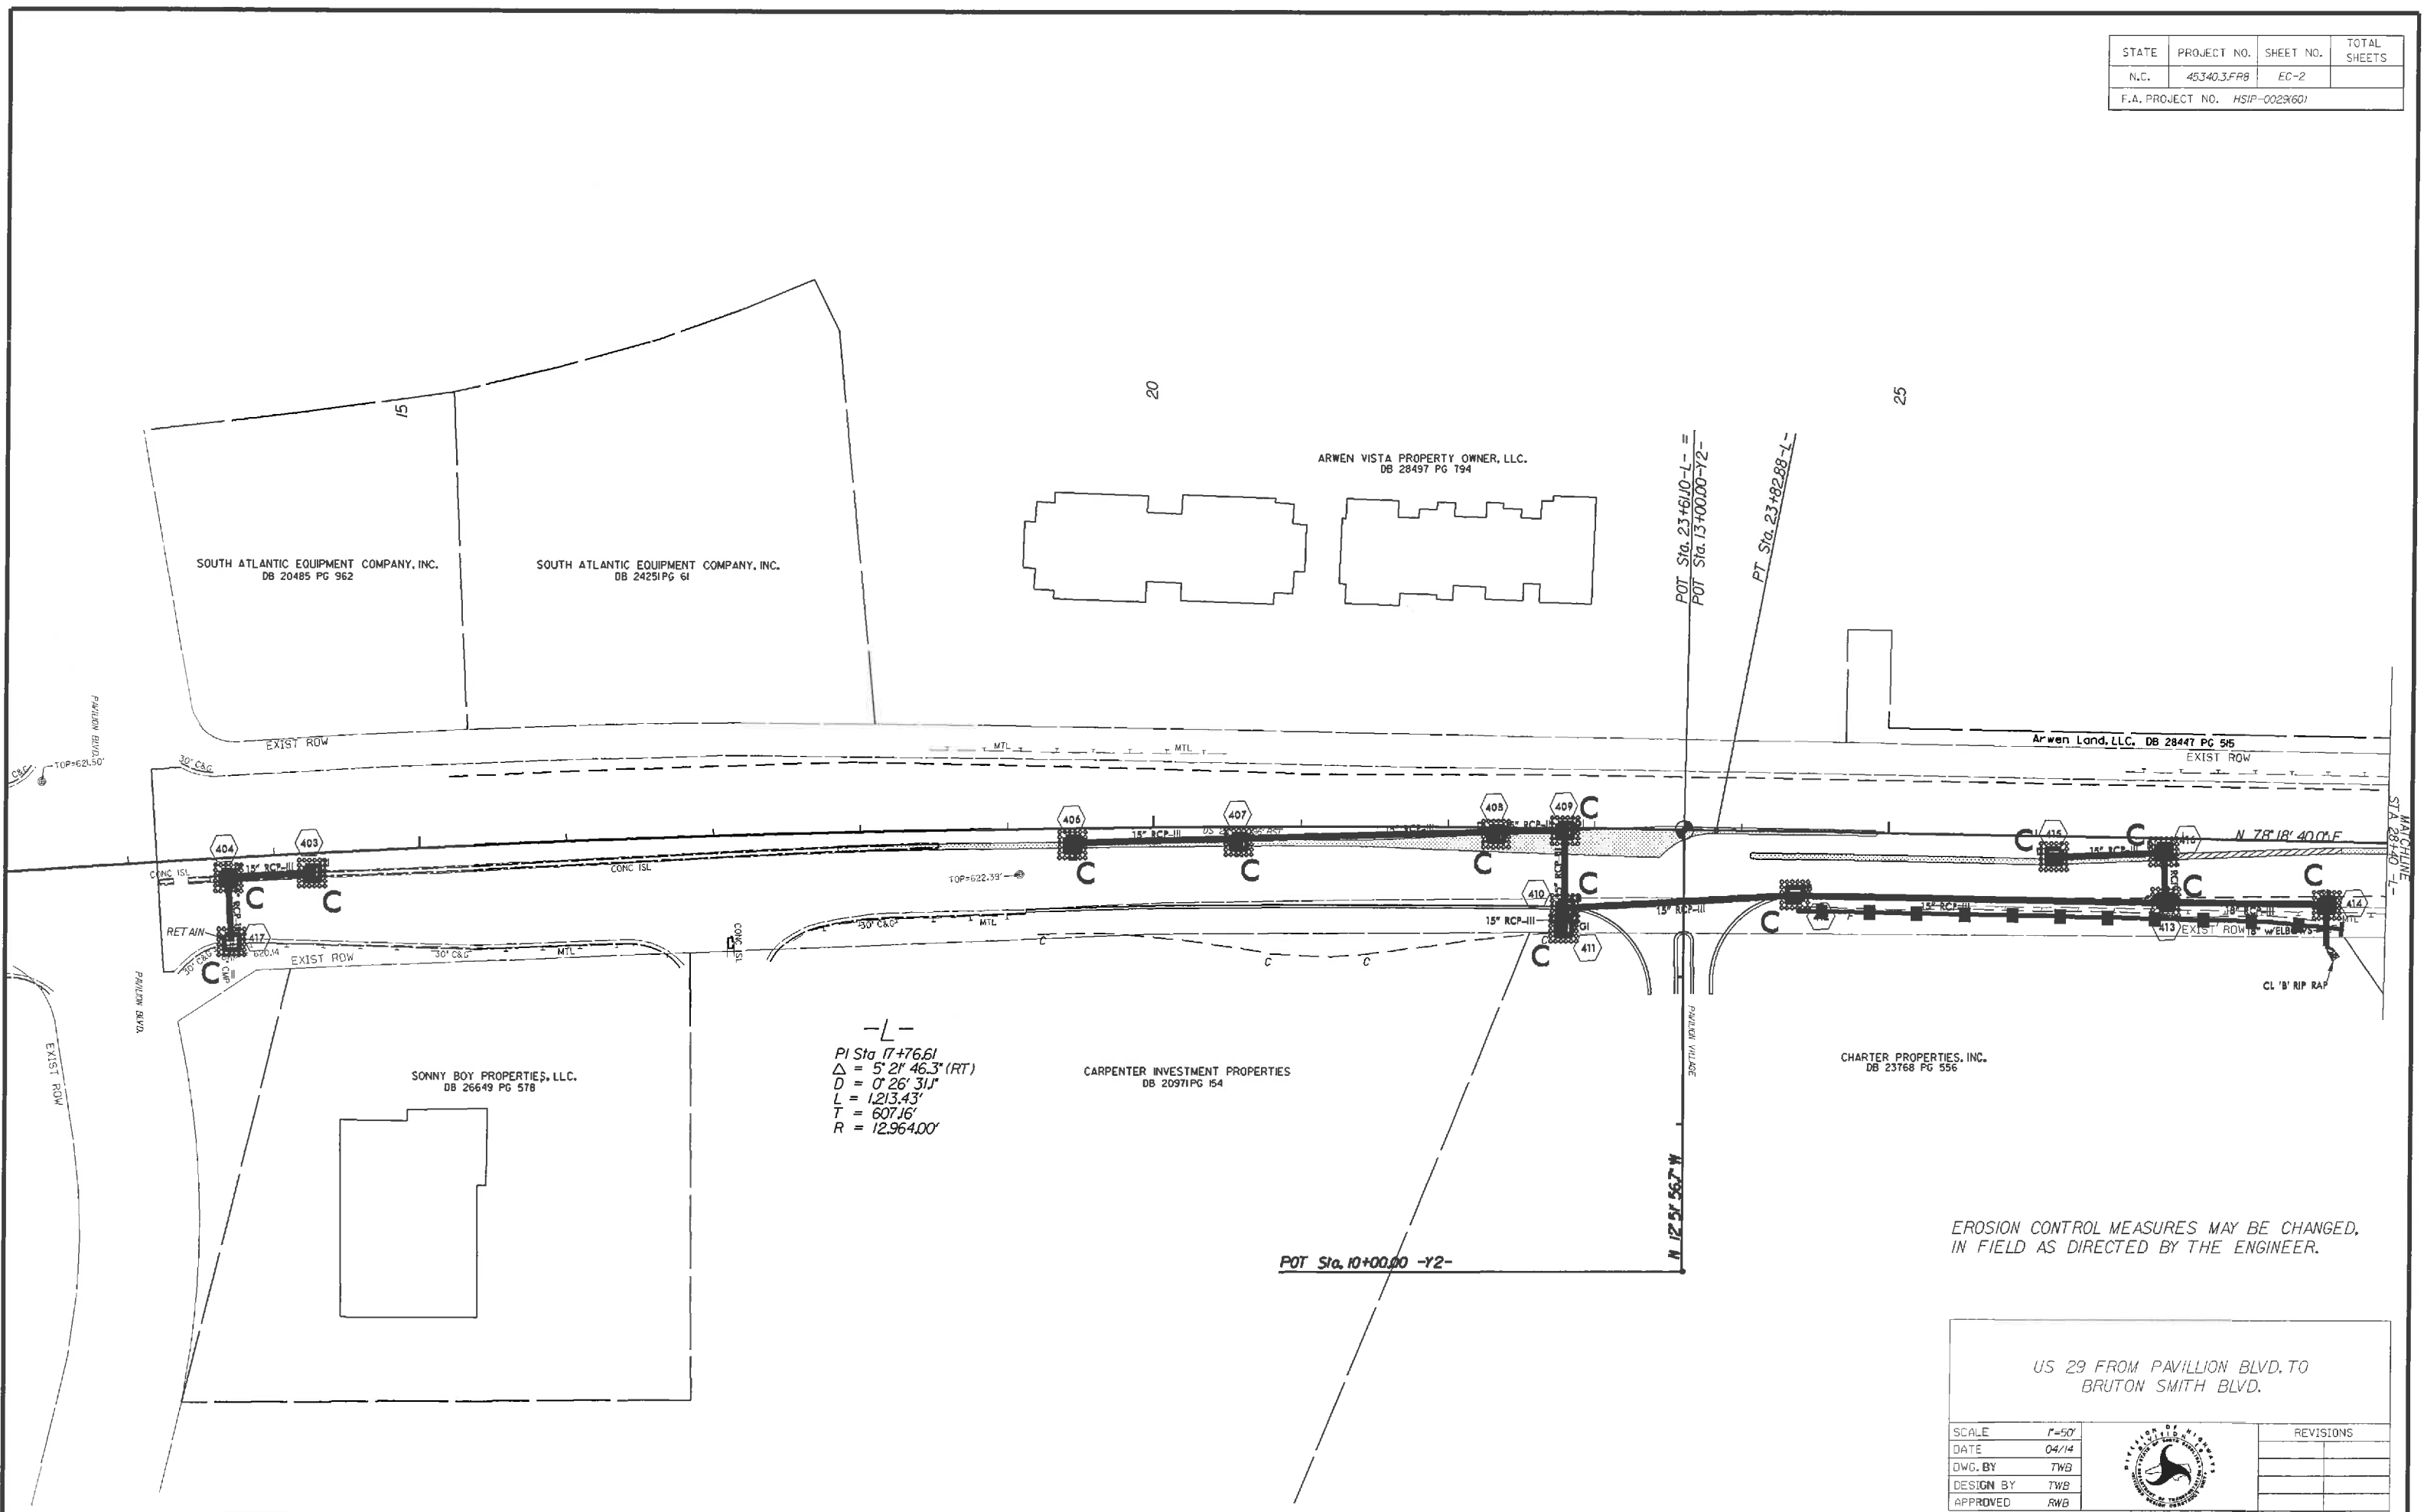


EROSION CONTROL MEASURES MAY BE CHANGED, IN FIELD AS DIRECTED BY THE ENGINEER.

US 29 FROM PAVILLION BLVD. TO BRUTON SMITH BLVD.

SCALE	1"=50'		REVISIONS
DATE	04/14		
DWG. BY	TWB		
DESIGN BY	TWB		
APPROVED	RWB		

STATE	PROJECT NO.	SHEET NO.	TOTAL SHEETS
N.C.	45340.3.FRB	EC-3	
F.A. PROJECT NO. HSIP-0029(60)			

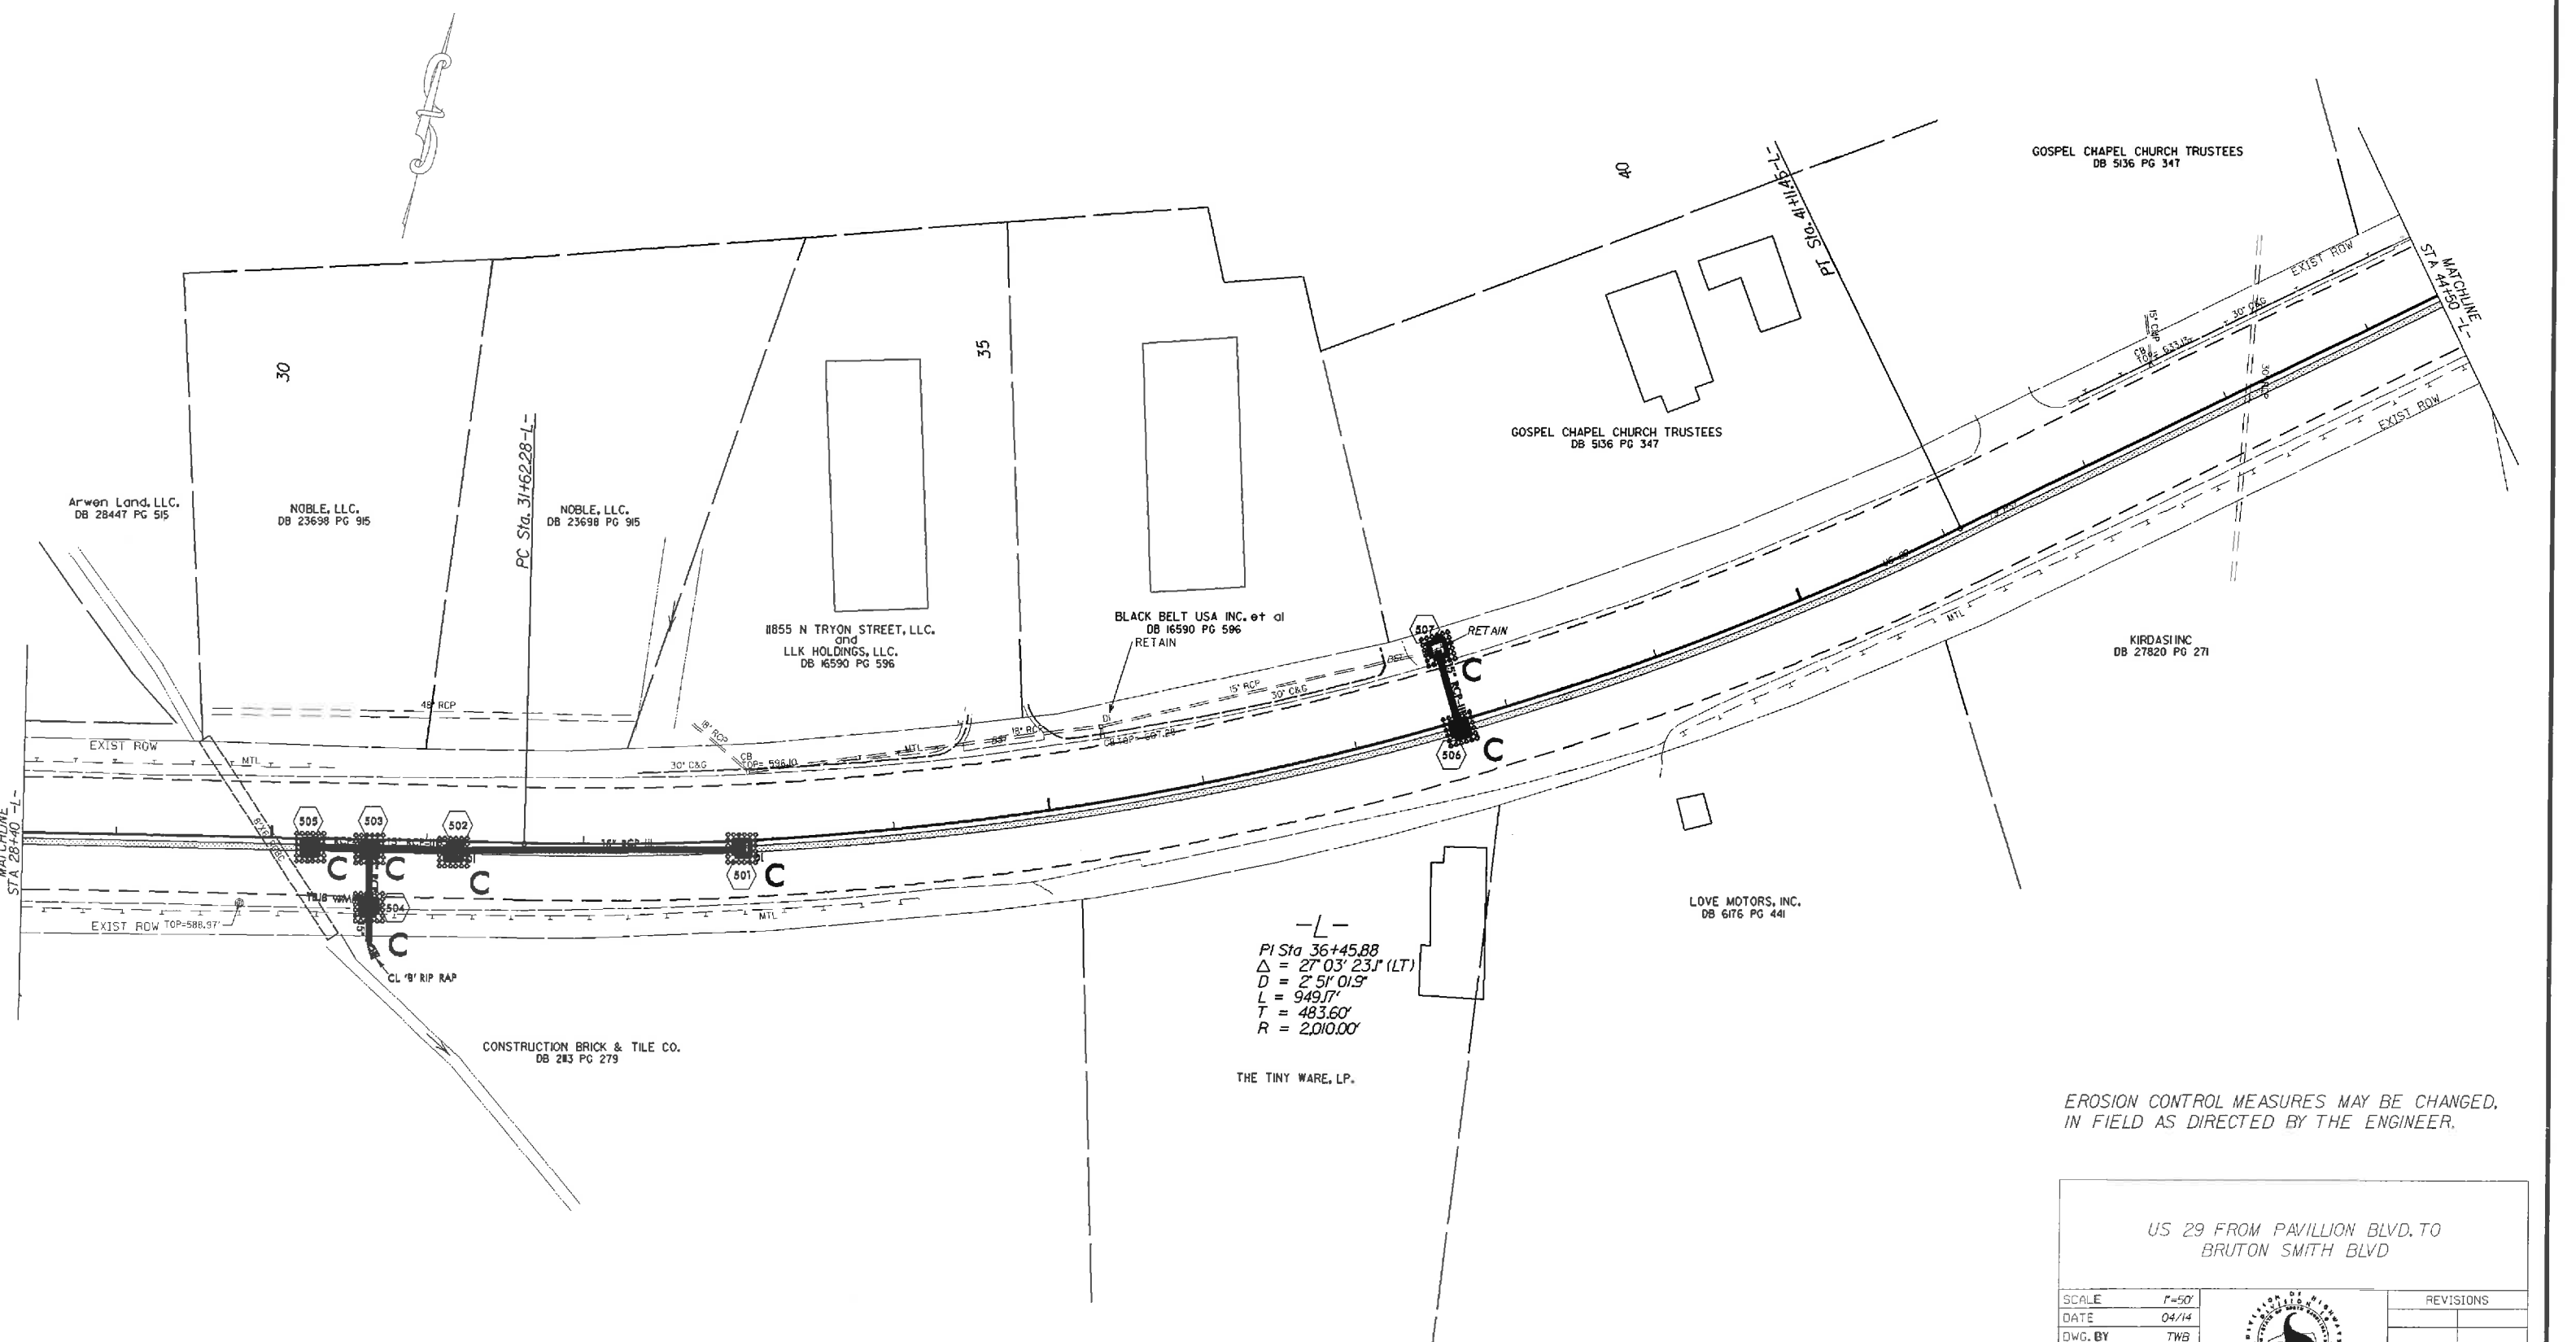

GOSPEL CHAPEL CHURCH TRUSTEES
DB 5136 PG 347

GOSPEL CHAPEL CHURCH TRUSTEES
DB 5136 PG 347

Arwen Land, LLC.
DB 28447 PG 515

NOBLE, LLC.
DB 23698 PG 915

NOBLE, LLC.
DB 23698 PG 915

1855 N TRYON STREET, LLC.
and
LLK HOLDINGS, LLC.
DB 16590 PG 596

BLACK BELT USA INC. et al
DB 16590 PG 596
RETAIN

KIRDASI INC
DB 27820 PG 271

LOVE MOTORS, INC.
DB 6176 PG 441


CONSTRUCTION BRICK & TILE CO.
DB 213 PG 279

-L-
PI Sta 36+45.88
Δ = 27° 03' 23.1" (LT)
D = 2' 51' 01.9"
L = 949.17'
T = 483.60'
R = 2,010.00'


THE TINY WARE, LP.

EROSION CONTROL MEASURES MAY BE CHANGED,
IN FIELD AS DIRECTED BY THE ENGINEER.

US 29 FROM PAVILLION BLVD. TO
BRUTON SMITH BLVD

SCALE	1"=50'		REVISIONS
DATE	04/14		
DWG. BY	TWB		
DESIGN BY	TWB		
APPROVED	RWB		

STATE	PROJECT NO.	SHEET NO.	TOTAL SHEETS
N.C.	45340.3.FRB	EC-4	
F.A. PROJECT NO.		HSIP-0029(60)	

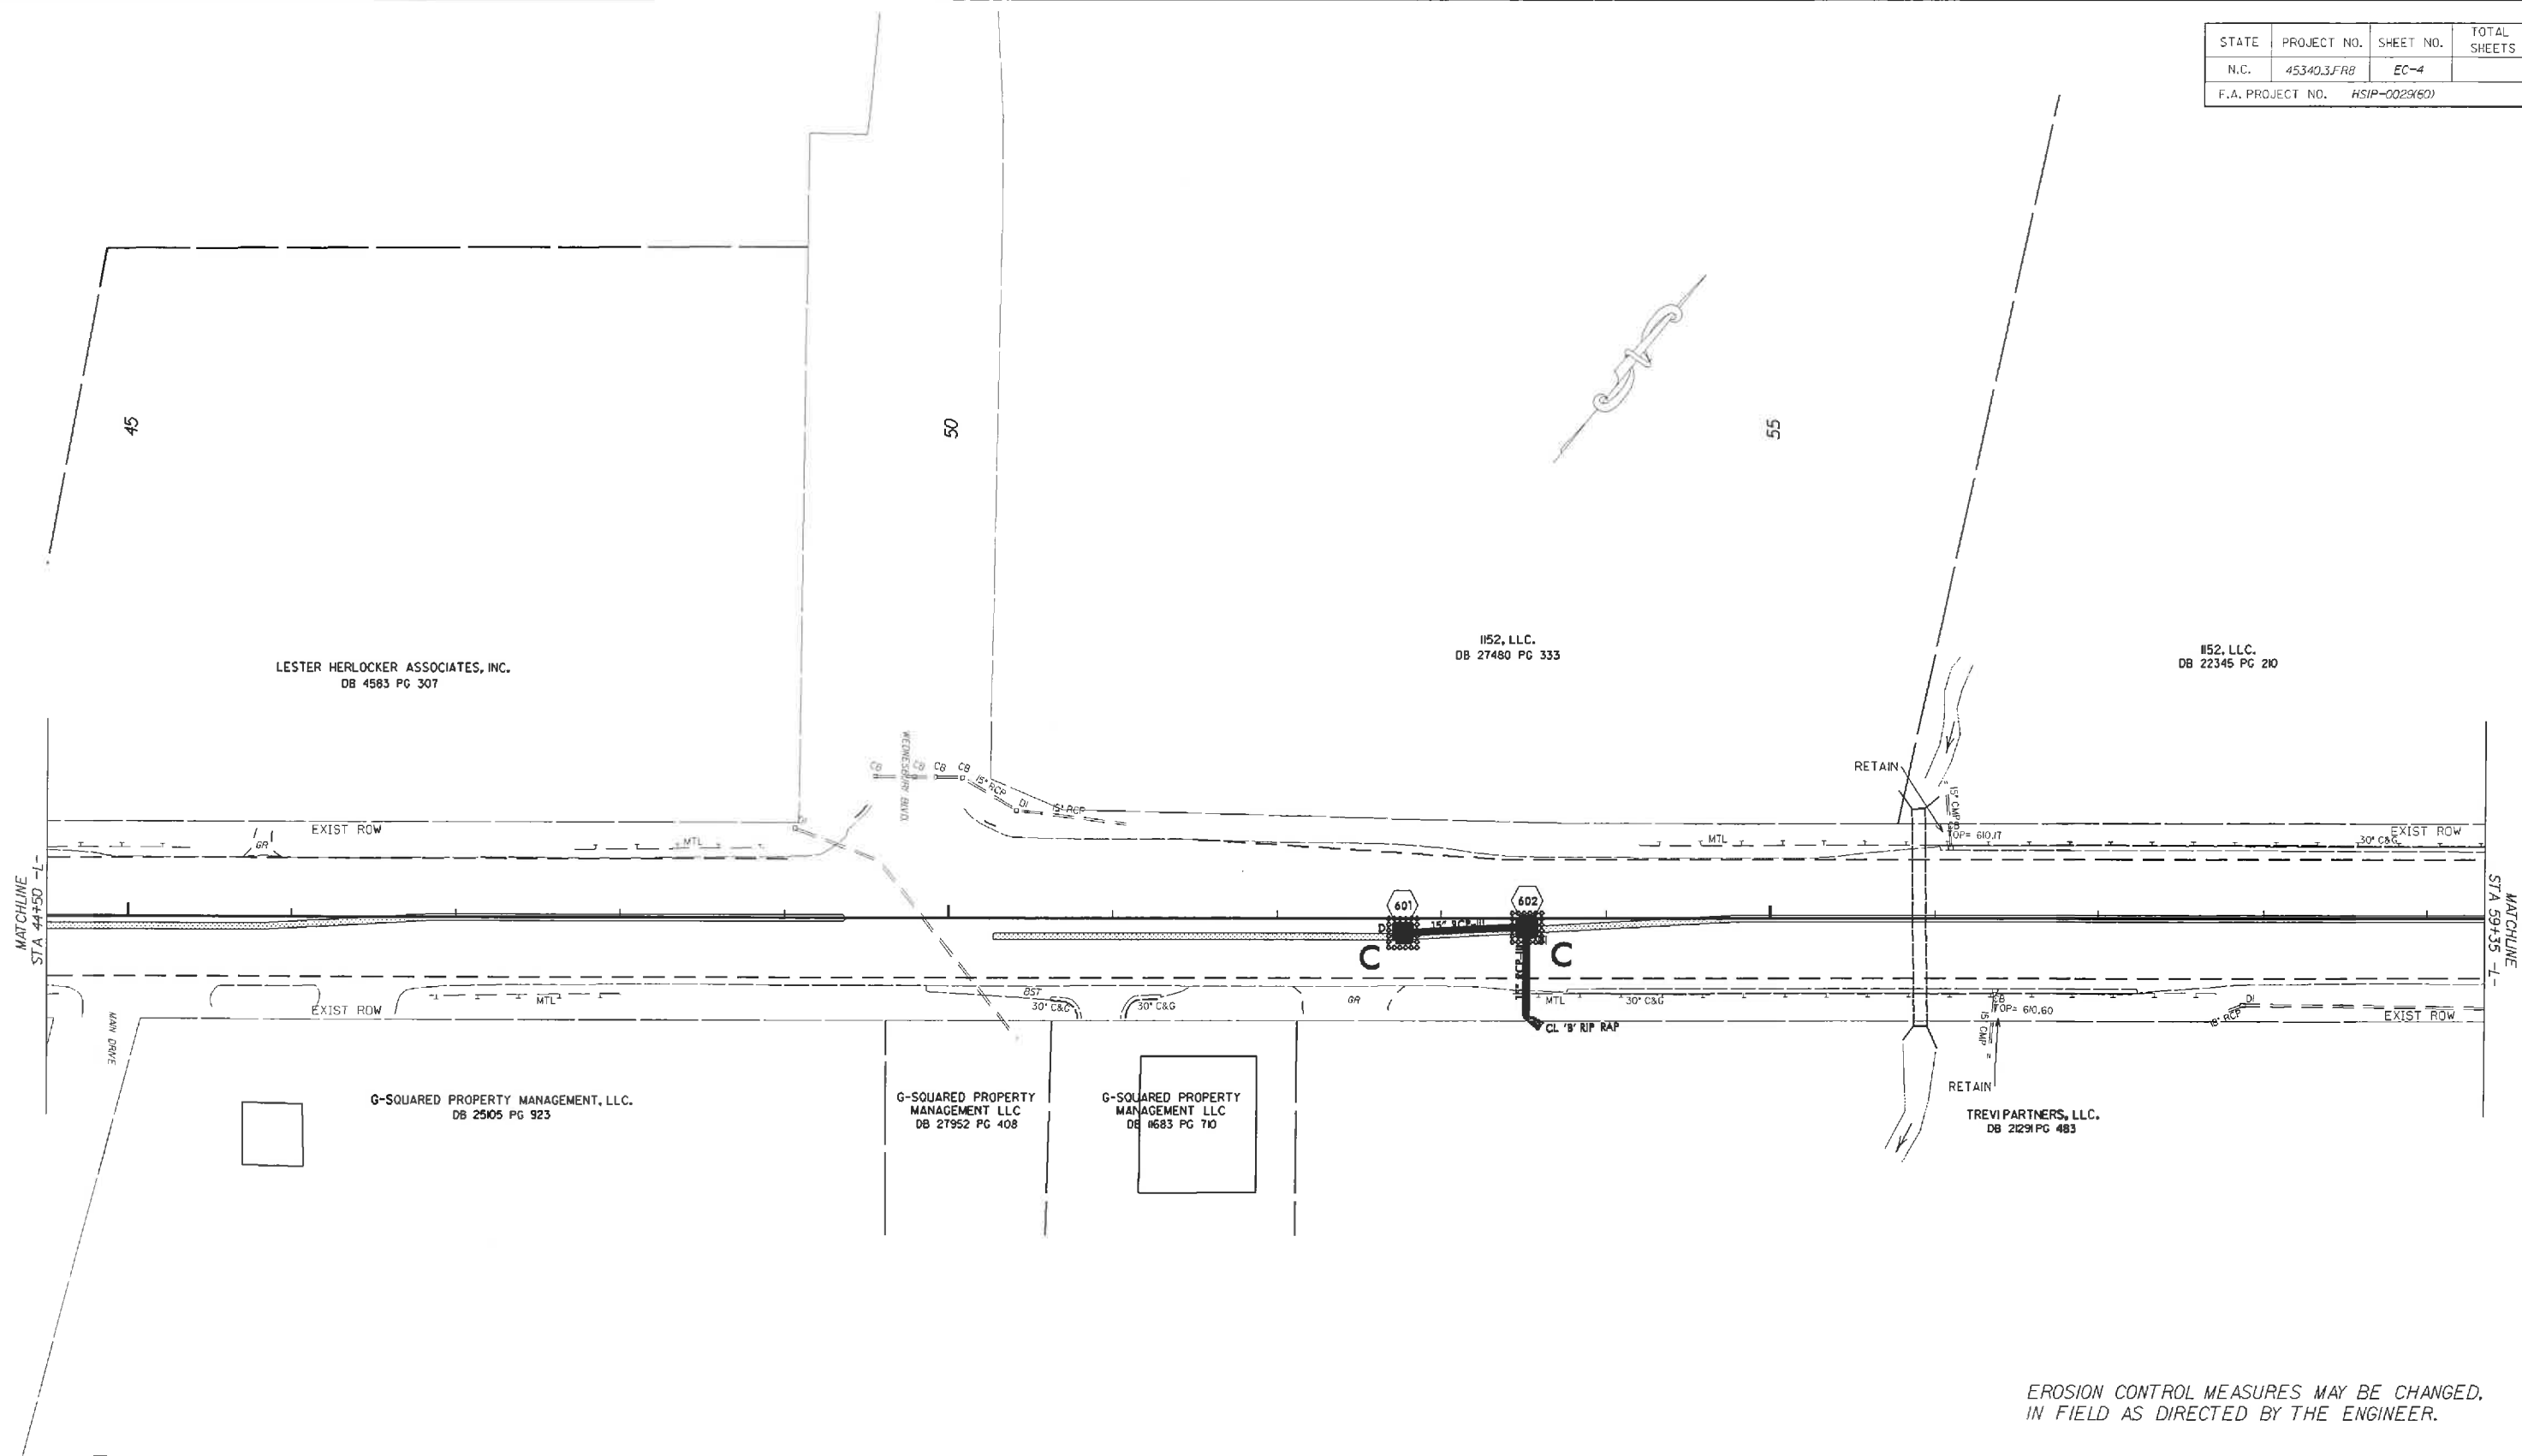


EROSION CONTROL MEASURES MAY BE CHANGED,
IN FIELD AS DIRECTED BY THE ENGINEER.

US 29 FROM PAVILLION BLVD. TO
BRUTON SMITH BLVD

SCALE	1"=50'		REVISIONS	
DATE	04/14			
DWG. BY	TWB			
DESIGN BY	TWB			
APPROVED	RWB			

STATE	PROJECT NO.	SHEET NO.	TOTAL SHEETS
N.C.	45340.3.FRB	EC-5	
F.A. PROJECT NO. H5IP-0029600			

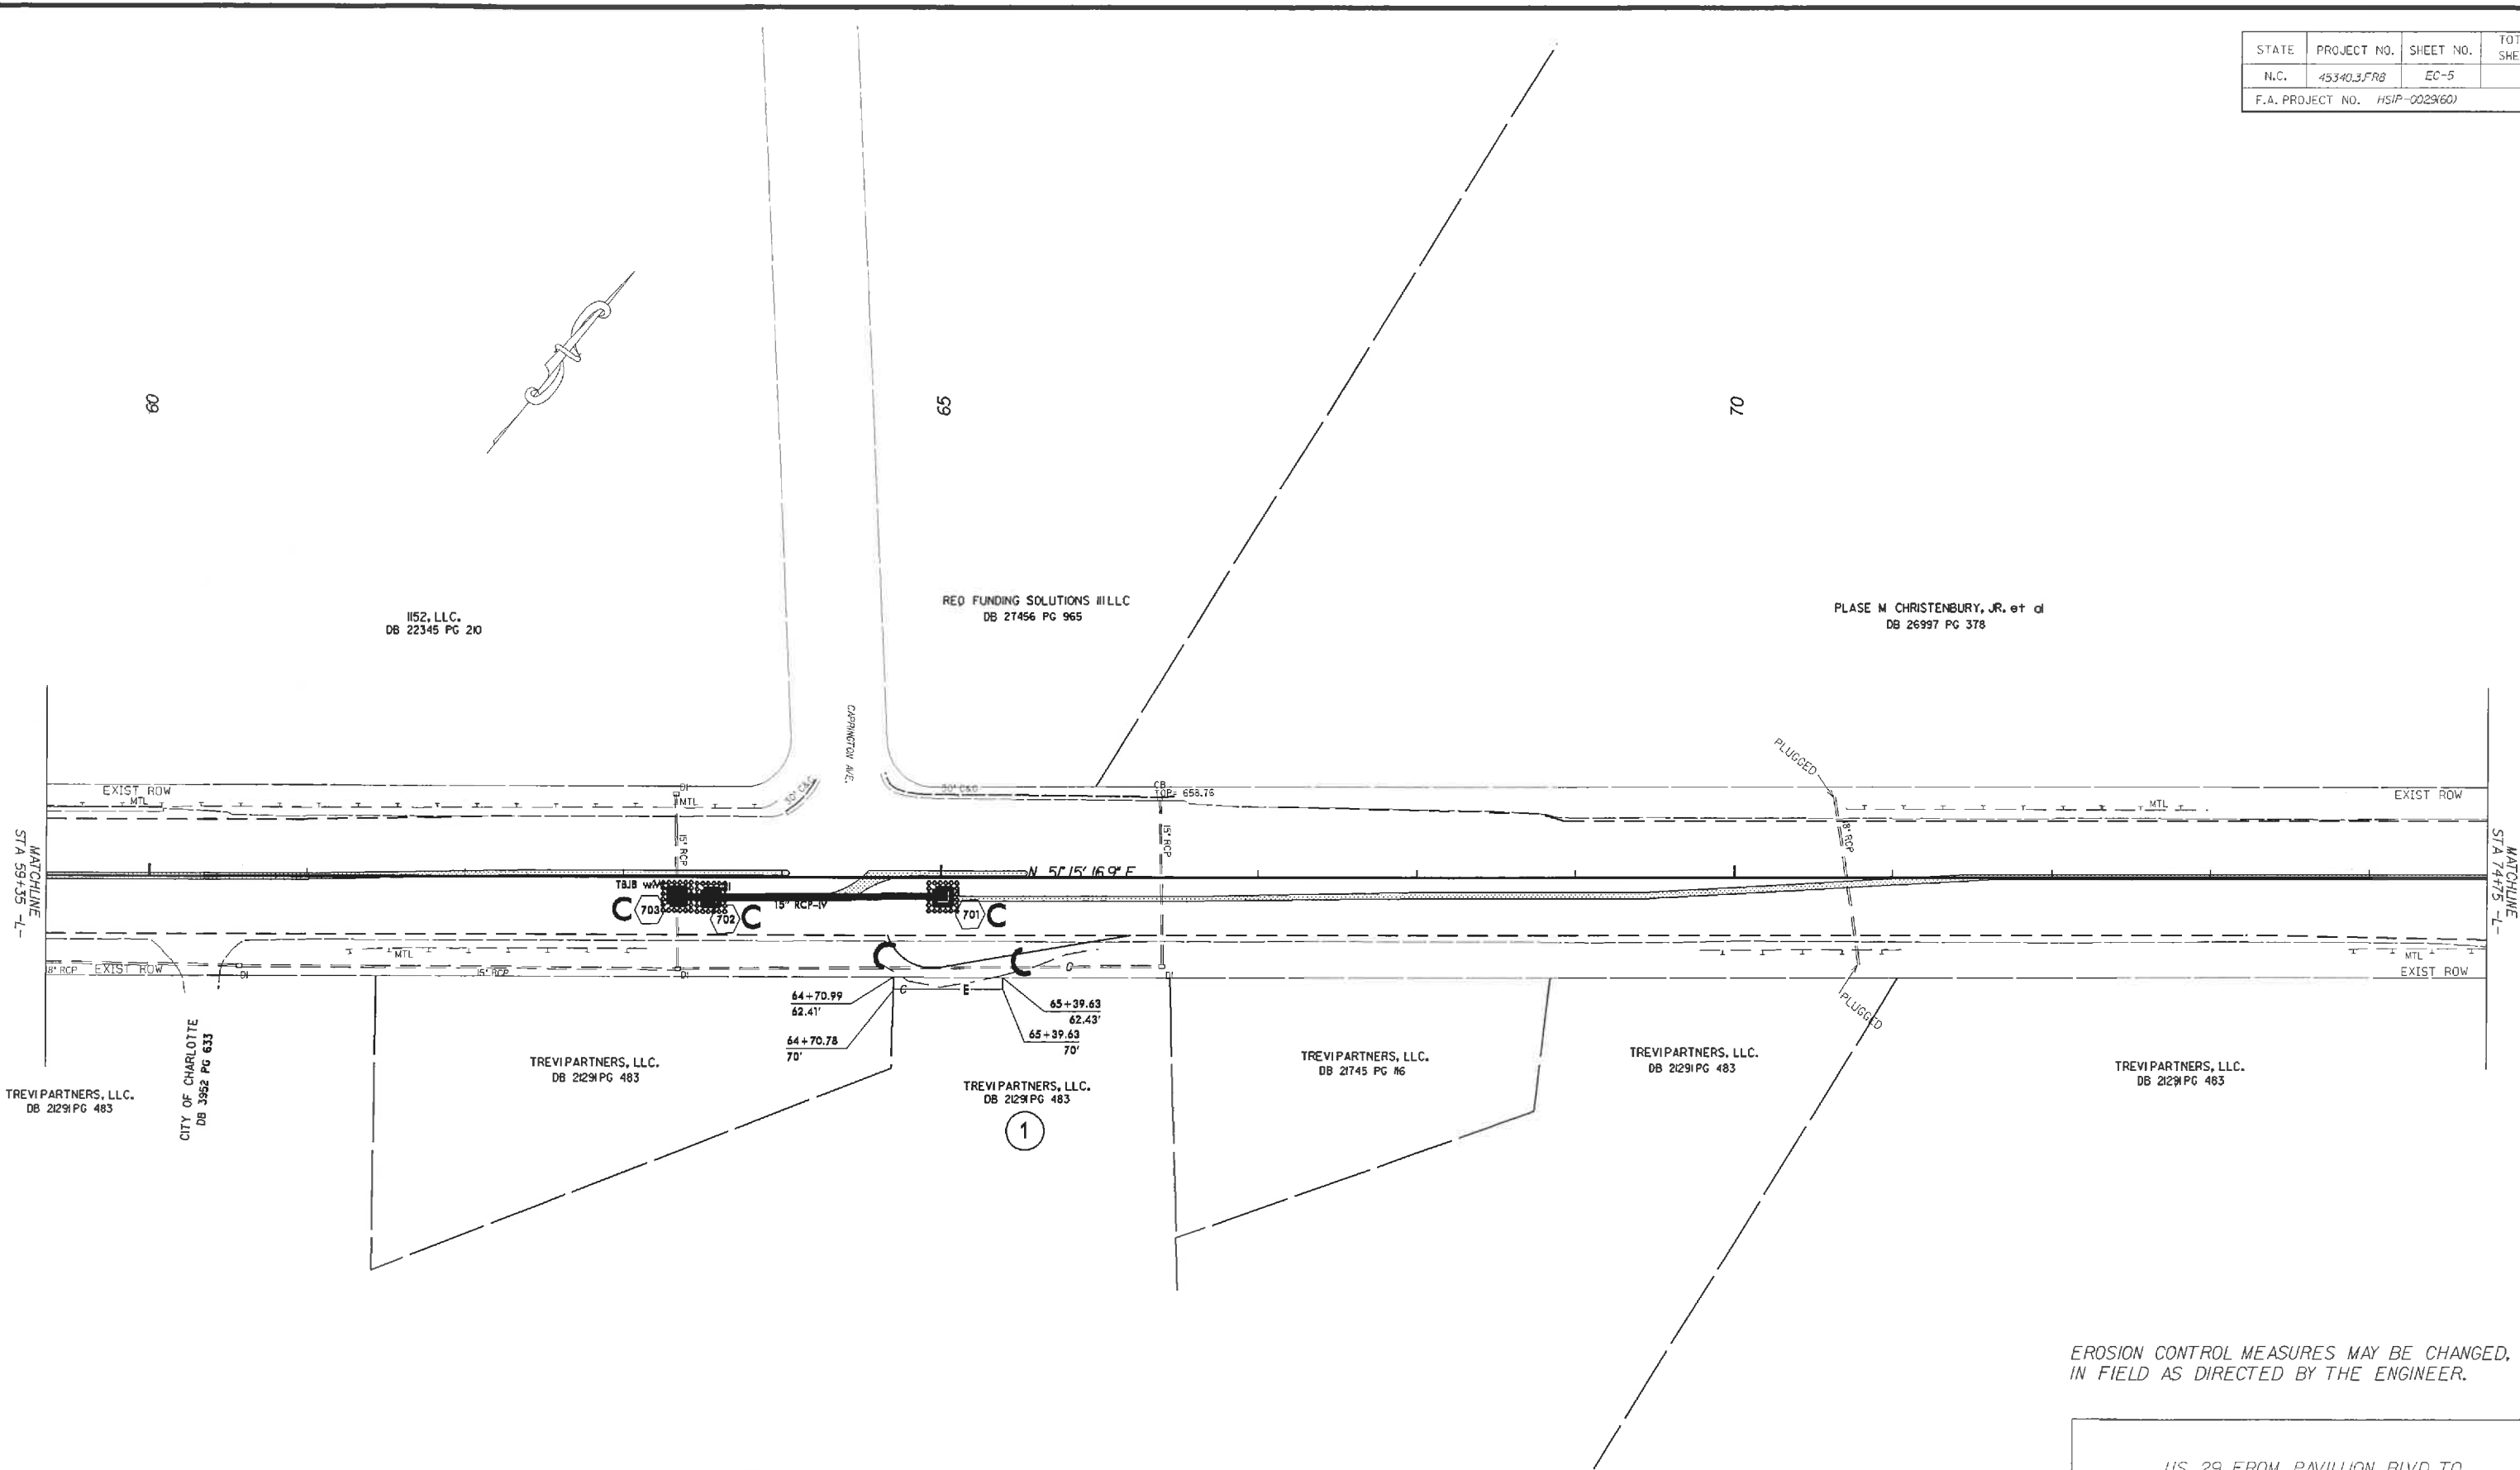

EROSION CONTROL MEASURES MAY BE CHANGED, IN FIELD AS DIRECTED BY THE ENGINEER.

PARCEL NO.	PARCEL OWNER	TOTAL ACREAGE	AREA TAKEN	AREA REMAINING	TEMP. CONST. EASE.	PERM. DRAIN. EASE.
1	TREVI PARTNERS, LLC.	N/A	N/A	N/A	521 SF.	N/A


US 29 FROM PAVILLION BLVD. TO BRUTON SMITH BLVD

SCALE	1"=50'		REVISIONS	
DATE	04/14			
DWG. BY	TWB			
DESIGN BY	TWB			
APPROVED	RWB			


STATE	PROJECT NO.	SHEET NO.	TOTAL SHEETS
N.C.	45340.3.FRB	EC-6	
F.A. PROJECT NO.		HSIP-00291601	

57 PLASE M CHRISTENBURY, JR. et al
DB 26997 PG 318

VILLAGE AT WITHROW DOWNS II
HOMEDWNERS ASSOC. INC.
DB 1411 PG 508

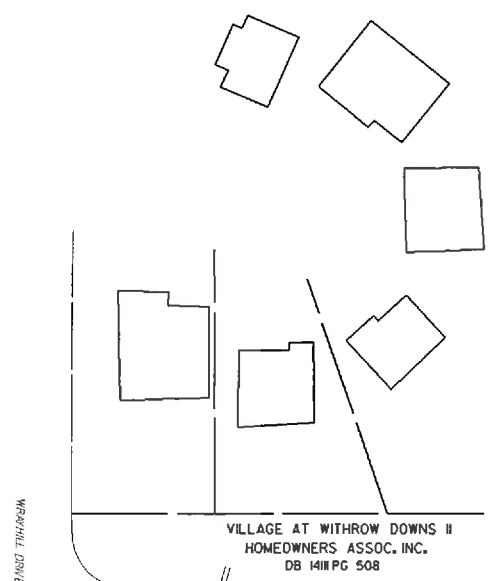


88

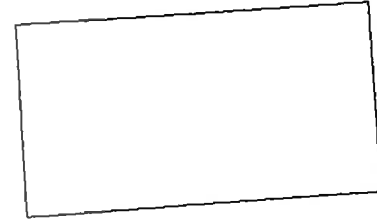

FLOYD SMITH OFFICE PARK, LLC.
NO DEED REFERENCE

85

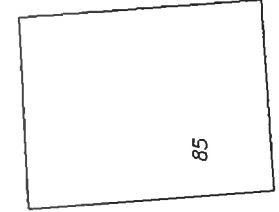

FLOYD SMITH OFFICE PARK, LLC.
NO DEED REFERENCE


96

PLASE M. CHRISTENBURY, JR.
DB 5208 PG 914

FLOYD SMITH OFFICE PARK, LLC.
DB 1236 PG 859

MATCHLINE
STA 74+75 -1-

MATCHLINE
STA 90+40 -1-

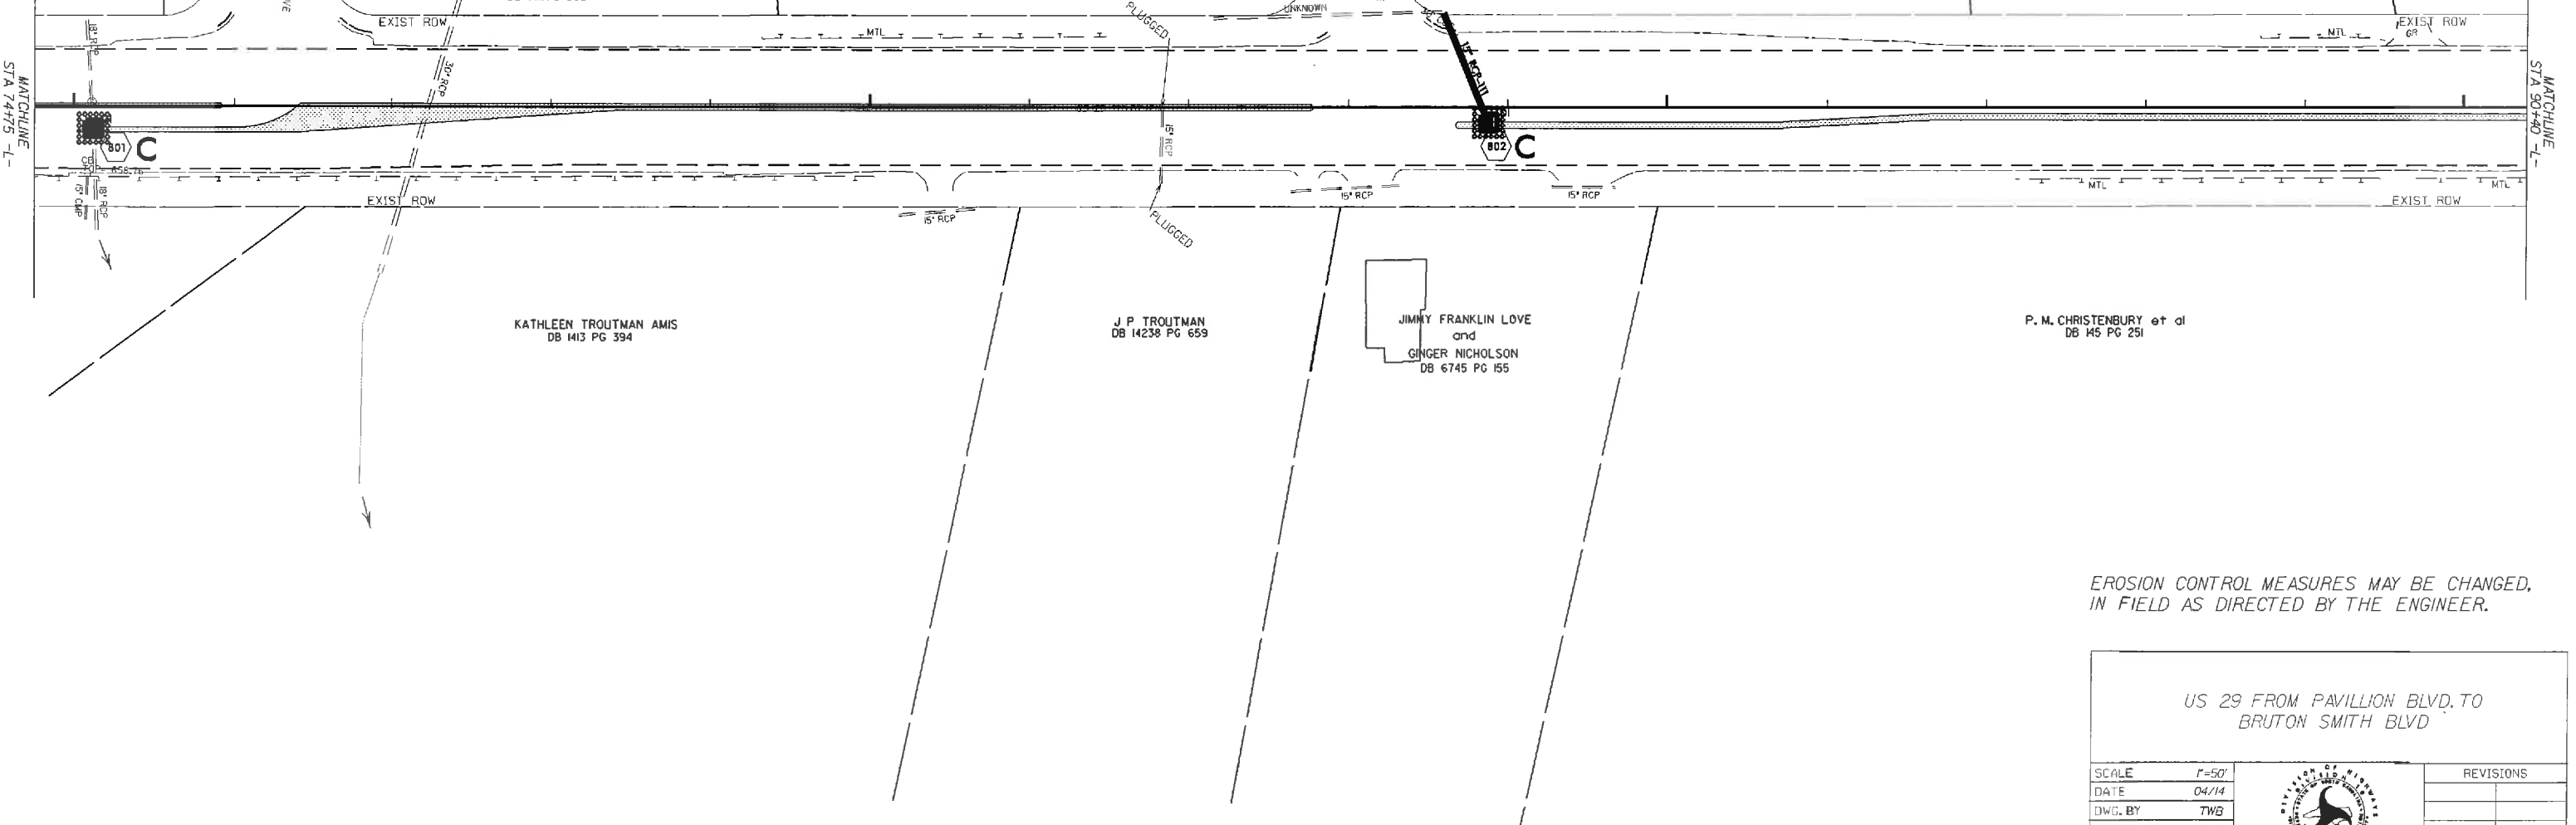

KATHLEEN TROUTMAN AMIS
DB 1413 PG 394

J.P. TROUTMAN
DB 14238 PG 659

JIMMY FRANKLIN LOVE
and
GINGER NICHOLSON
DB 6745 PG 155

P. M. CHRISTENBURY et al
DB 145 PG 251

EROSION CONTROL MEASURES MAY BE CHANGED,
IN FIELD AS DIRECTED BY THE ENGINEER.

US 29 FROM PAVILLION BLVD. TO
BRUTON SMITH BLVD


SCALE	1"=50'
DATE	04/14
DWG. BY	TWB
DESIGN BY	TWB
APPROVED	RWB



REVISIONS	


STATE	PROJECT NO.	SHEET NO.	TOTAL SHEETS
N.C.	45340.3.FRB	EC-7	
F.A. PROJECT NO.		HSIP-0029(60)	

105

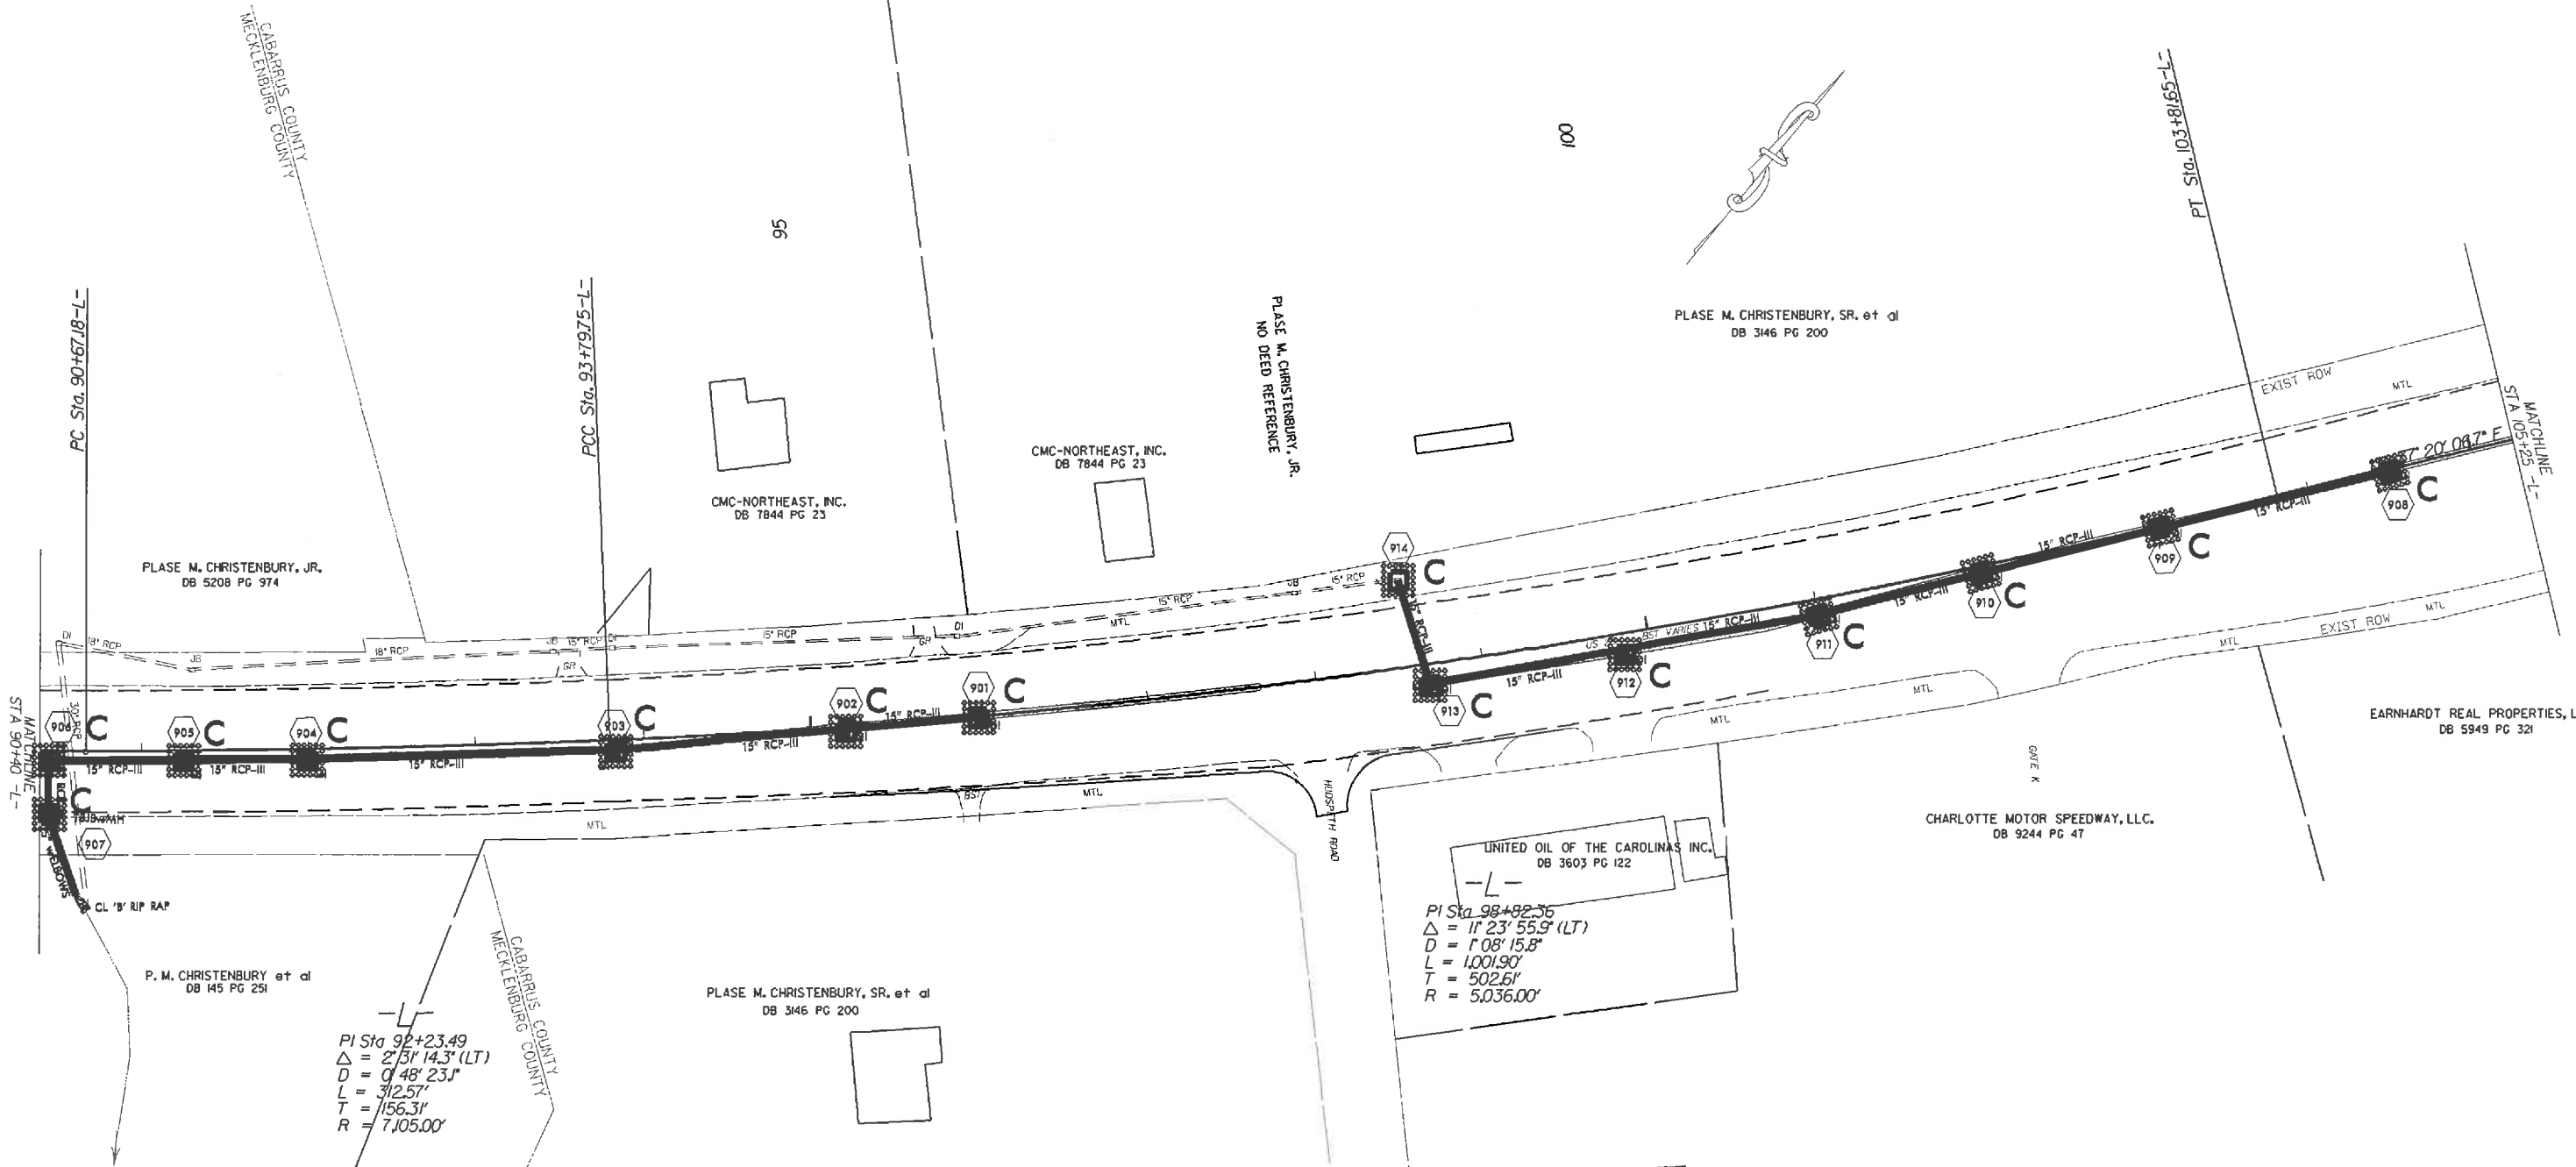

EROSION CONTROL MEASURES MAY BE CHANGED, IN FIELD AS DIRECTED BY THE ENGINEER.

US 29 FROM PAVILLION BLVD. TO BRUTON SMITH BLVD

SCALE	1"=50'		REVISIONS
DATE	04/14		
DWG. BY	TWB		
DESIGN BY	TWB		
APPROVED	RWB		